


SCALE: NTS

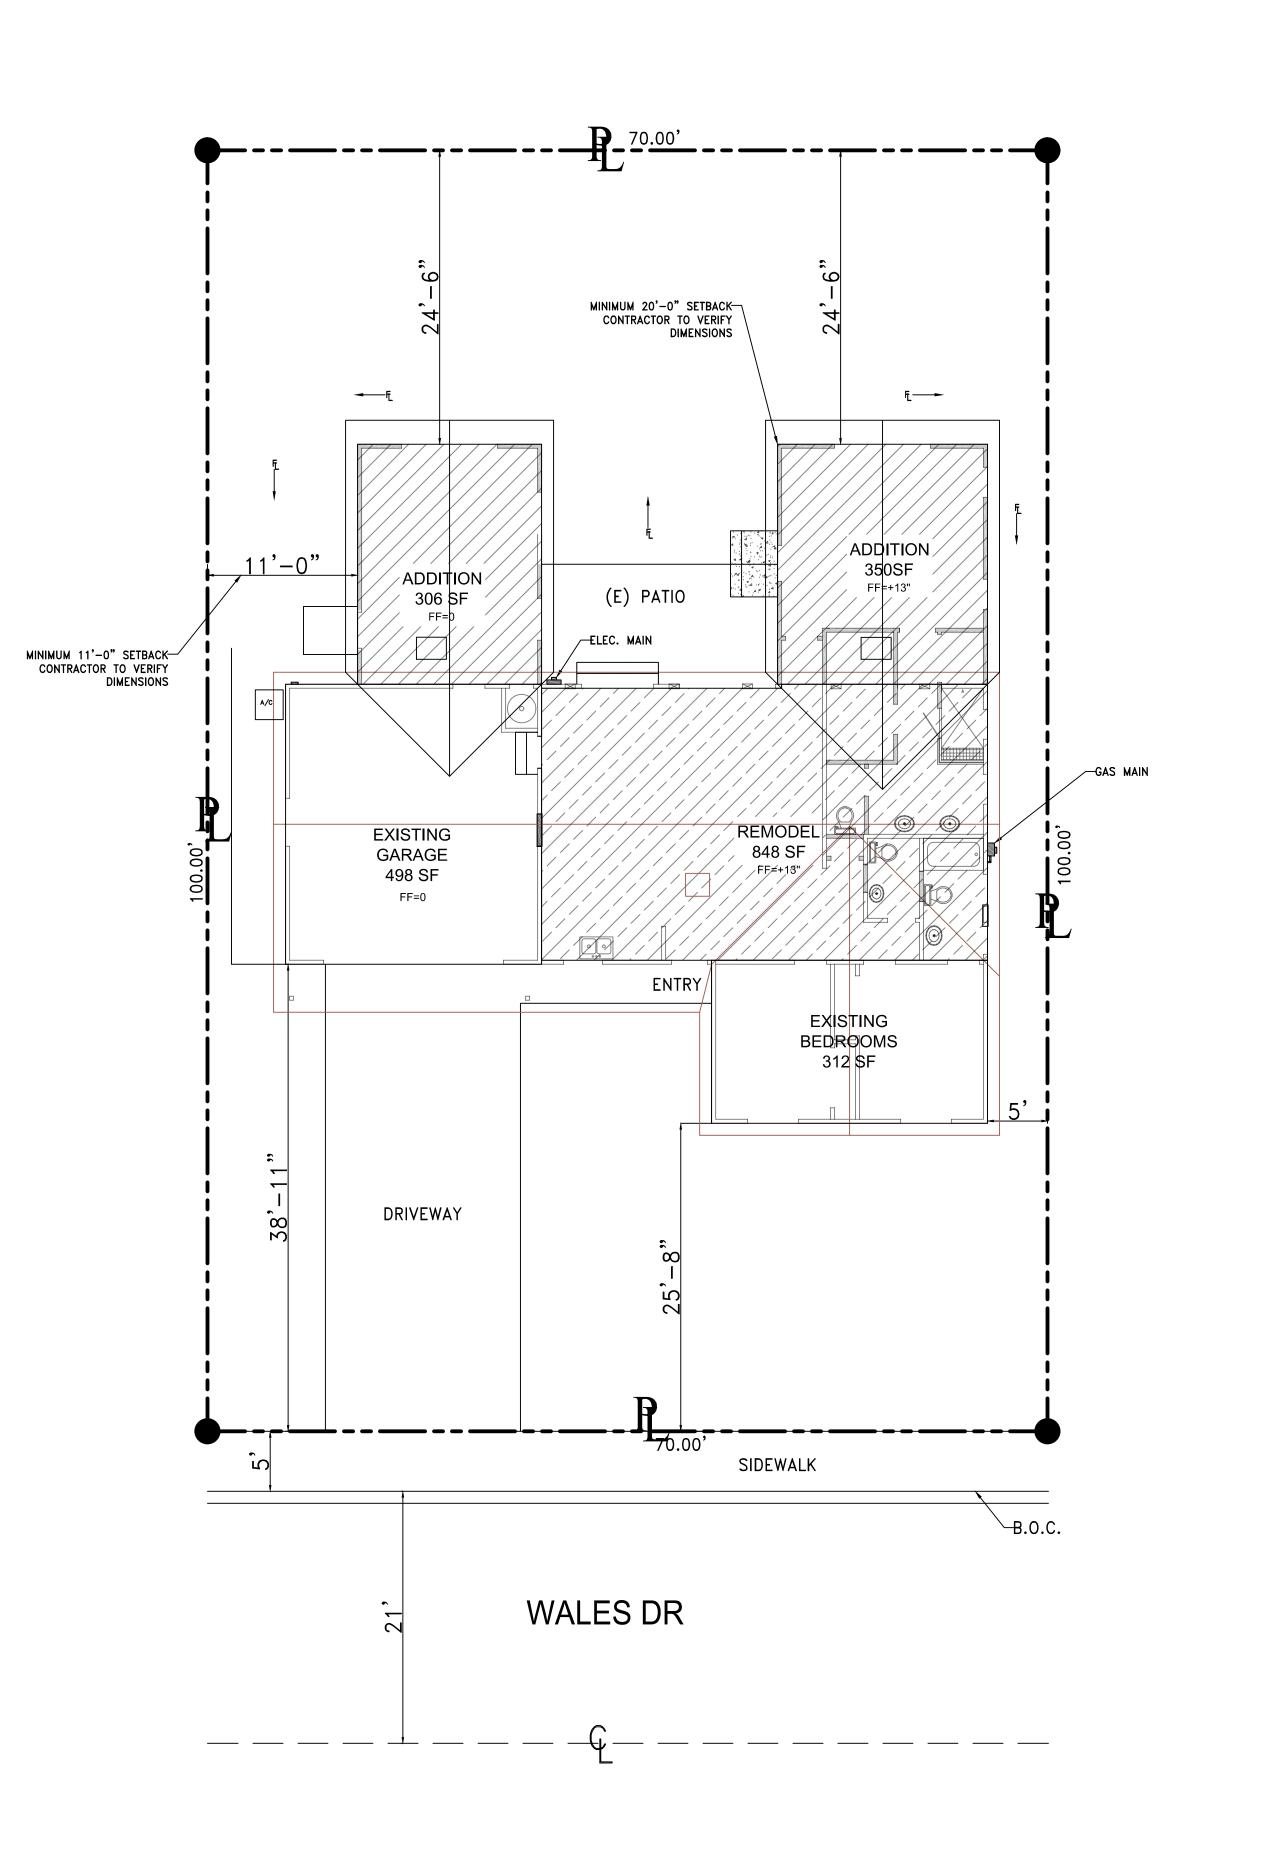

SITE PLAN

NOTE: CONTRACTOR TO FIELD VERIFY DIMENSIONS

SCOPE OF WORK:

RESIDENTIAL ADDITION AND REMODEL DEMO EXISTING FIREPLACE AND INTERIOR PARTITION WALL BETWEEN KITCHEN AND LIVING

JOHO TO THE STATE OF THE STATE

NOILION

 \triangleleft

 \triangleleft

 $A \supset A$

000

30

o 0

Ž 0

200

D 5(

 \Box AL C,

60. 07.1

9

 \geq

BATHROOM REMODEL

 ADDITION OFF THE BACK OF HOUSE FOR A LARGER MASTER BEDROOM AND BATH

• ADDITION OFF THE BACK OF GARAGE FOR WORKSHOP

PROPERTY OWNER: ELLEN & MIKE MATHIS PHONE: 1-916-769-3698 EMAIL: ILOVINJ@HOTMAIL .COM ADDRESS: 604 WALES DR. FOLSOM, CA 95630

DESIGNER: AVIGNON DESIGN BRANDON THATCHER PHONE - 916-889-2700

CLIMATE ZONE: 12

PROPERTY INFORMATION:

- LOT #12
- STORÏES: 1 FIELD MAP NAME: NATOMAS HEIGHTS 03
- ZONE: R-1-M
- PARCEL AREA: 7000 SQ. FT / 0.16 AC BUILDING SQUARE FOOTAGE: 1,196

NO OAK TREES AND/OR CHANGE TO EXISTING OAK

THIS PROJECT TO COMPLY WITH ALL CURRENT LOCAL & STATE LAWS & REGULATIONS.

ALSO TO COMPLY WITH THE FOLLOWING CODES: CALIFORNIA RESIDENTIAL CODE 2019 EDITION CALIFORNIA GREEN BLDG STDS 2019 EDITION CALIFORNIA BUILDING CODE 2019 EDITION (2016 IBC) CALIFORNIA FIRE CODE 2019 EDITION CALIFORNIA PLUMBING CODE 2019 EDITION CALIFORNIA ELECTRICAL CODE 2019 EDITION CALIFORNIA MECHANICAL CODE 2019 EDITION CALIFORNIA ENERGY CODE 2019 EDITION

SEE 2019 CALIFORNIA GREEN BUILDING STANDARDS CODE OF REGULATIONS, TITLE 24, PART 11 FOR CALGREEN REQUIREMENTS.

SQUARE FOOTAGE SUMMARY

EXISTING DWELLING — GARAGE — 1,196 SF REMODEL AREA -ADDITION -656 SF

TOTAL CONDITIONED SQUARE FEET = 1,852 SF

ABBREVIATION LEGEND:

SC:

SCALE 1/8" = 1'-0"

ABOVE HEAD HEIGHT HDR: HEADER TEMPERED GLASS CS: WDW: CASEMENT WINDOW WINDOW PL-HGT: PLATE HEIGHT **EXISTING** (N): SGD: SLIDING GLASS DOOR

SOLID CORE DRAWING INDEX

A-1 SITE/COVER SHEET A-2.1 EXISTING AND DEMO PLAN A-2.2 PROPOSED NEW FLOOR PLAN

A-3 FOUNDATION PLAN A-4 ROOF FRAMING A-5 EXTERIOR ELEVATIONS

A-6 SECTIONS A-7 NOT USED

A-8 ELECTRICAL PLAN A-9 GENERAL NOTES

EN-0 ENERGY COMPLIANCE REPORT EN-1 ENERGY COMPLIANCE REPORT


SHEET NO:

DESIGNED BY:

DRAWN BY: BT

3-17-22

PROJECT NO: 929

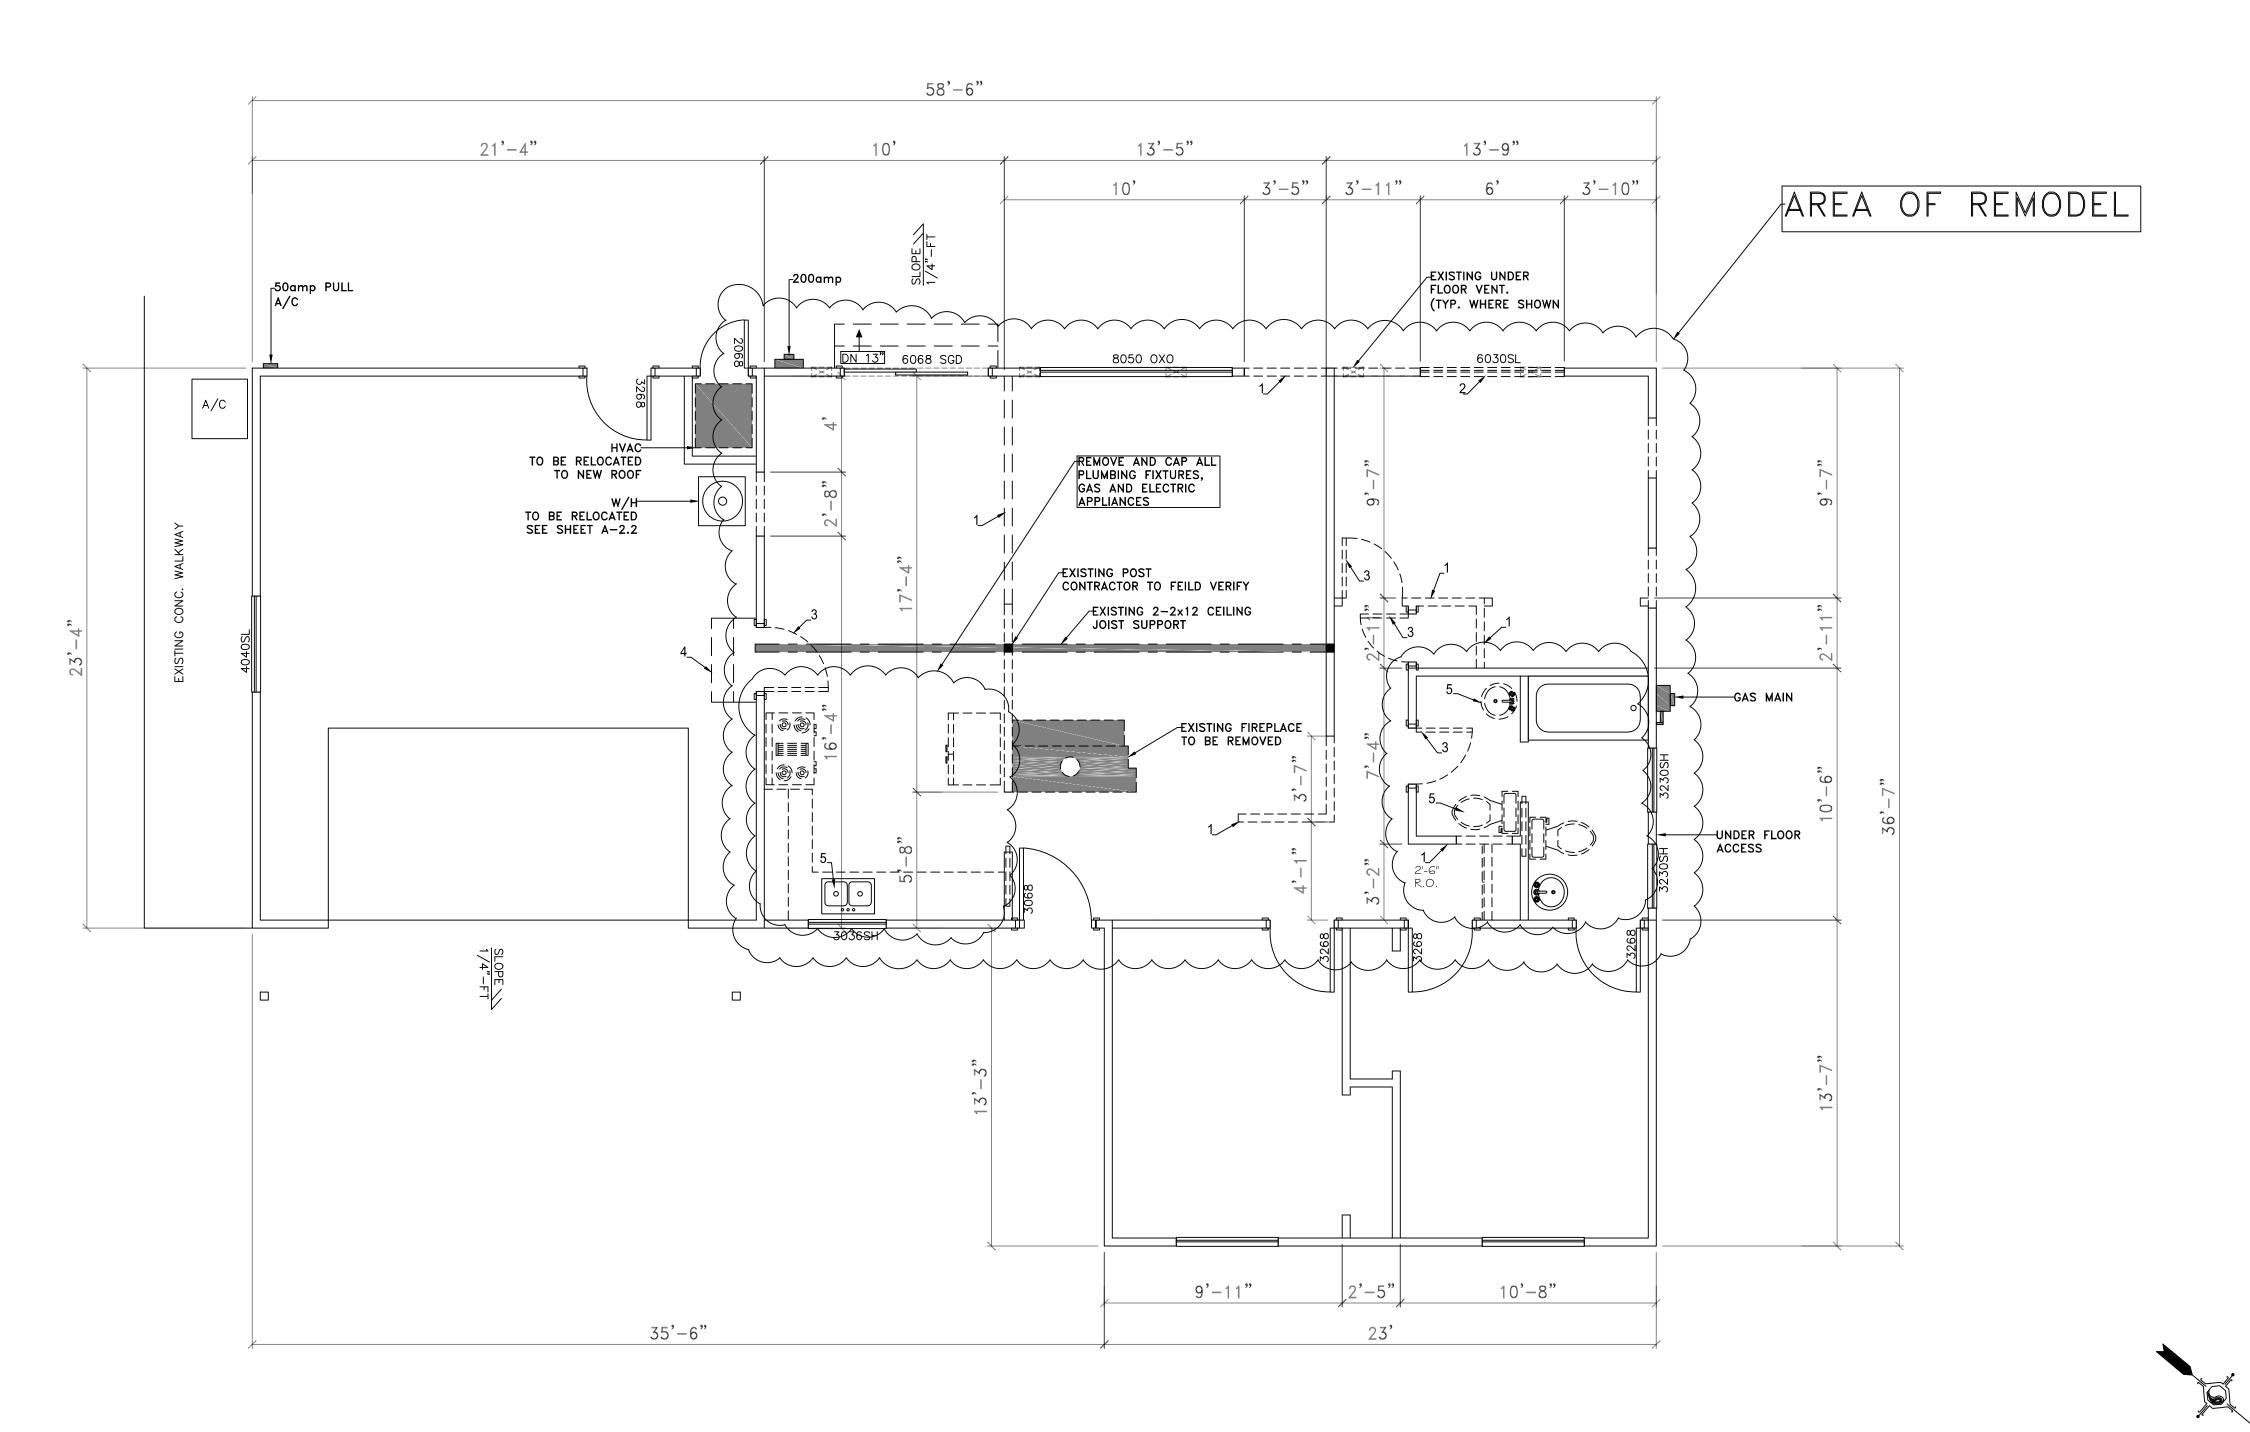


EXISTING FLOOR PLAN AND DEMO

SCALE: 1/4"= 1'-0"

AVIGNON

THE THE TOTAL STATE OF THE STATE OF

ATHIS FAMILY REMODEL/ADDITION
604 WALES DR
FOLSOM, CA 95630
APN: 071-0121-010-0000

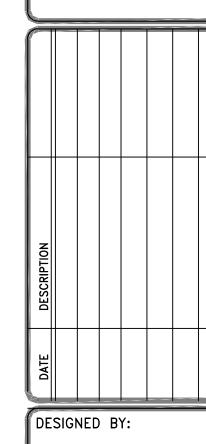

SIGNED BY:

DRAWN BY: BT


DATE: 3-17-22

3-17-22 PROJECT NO: 929

> EXISTING LOOR PLAN

SHEET NO:

A-2.1

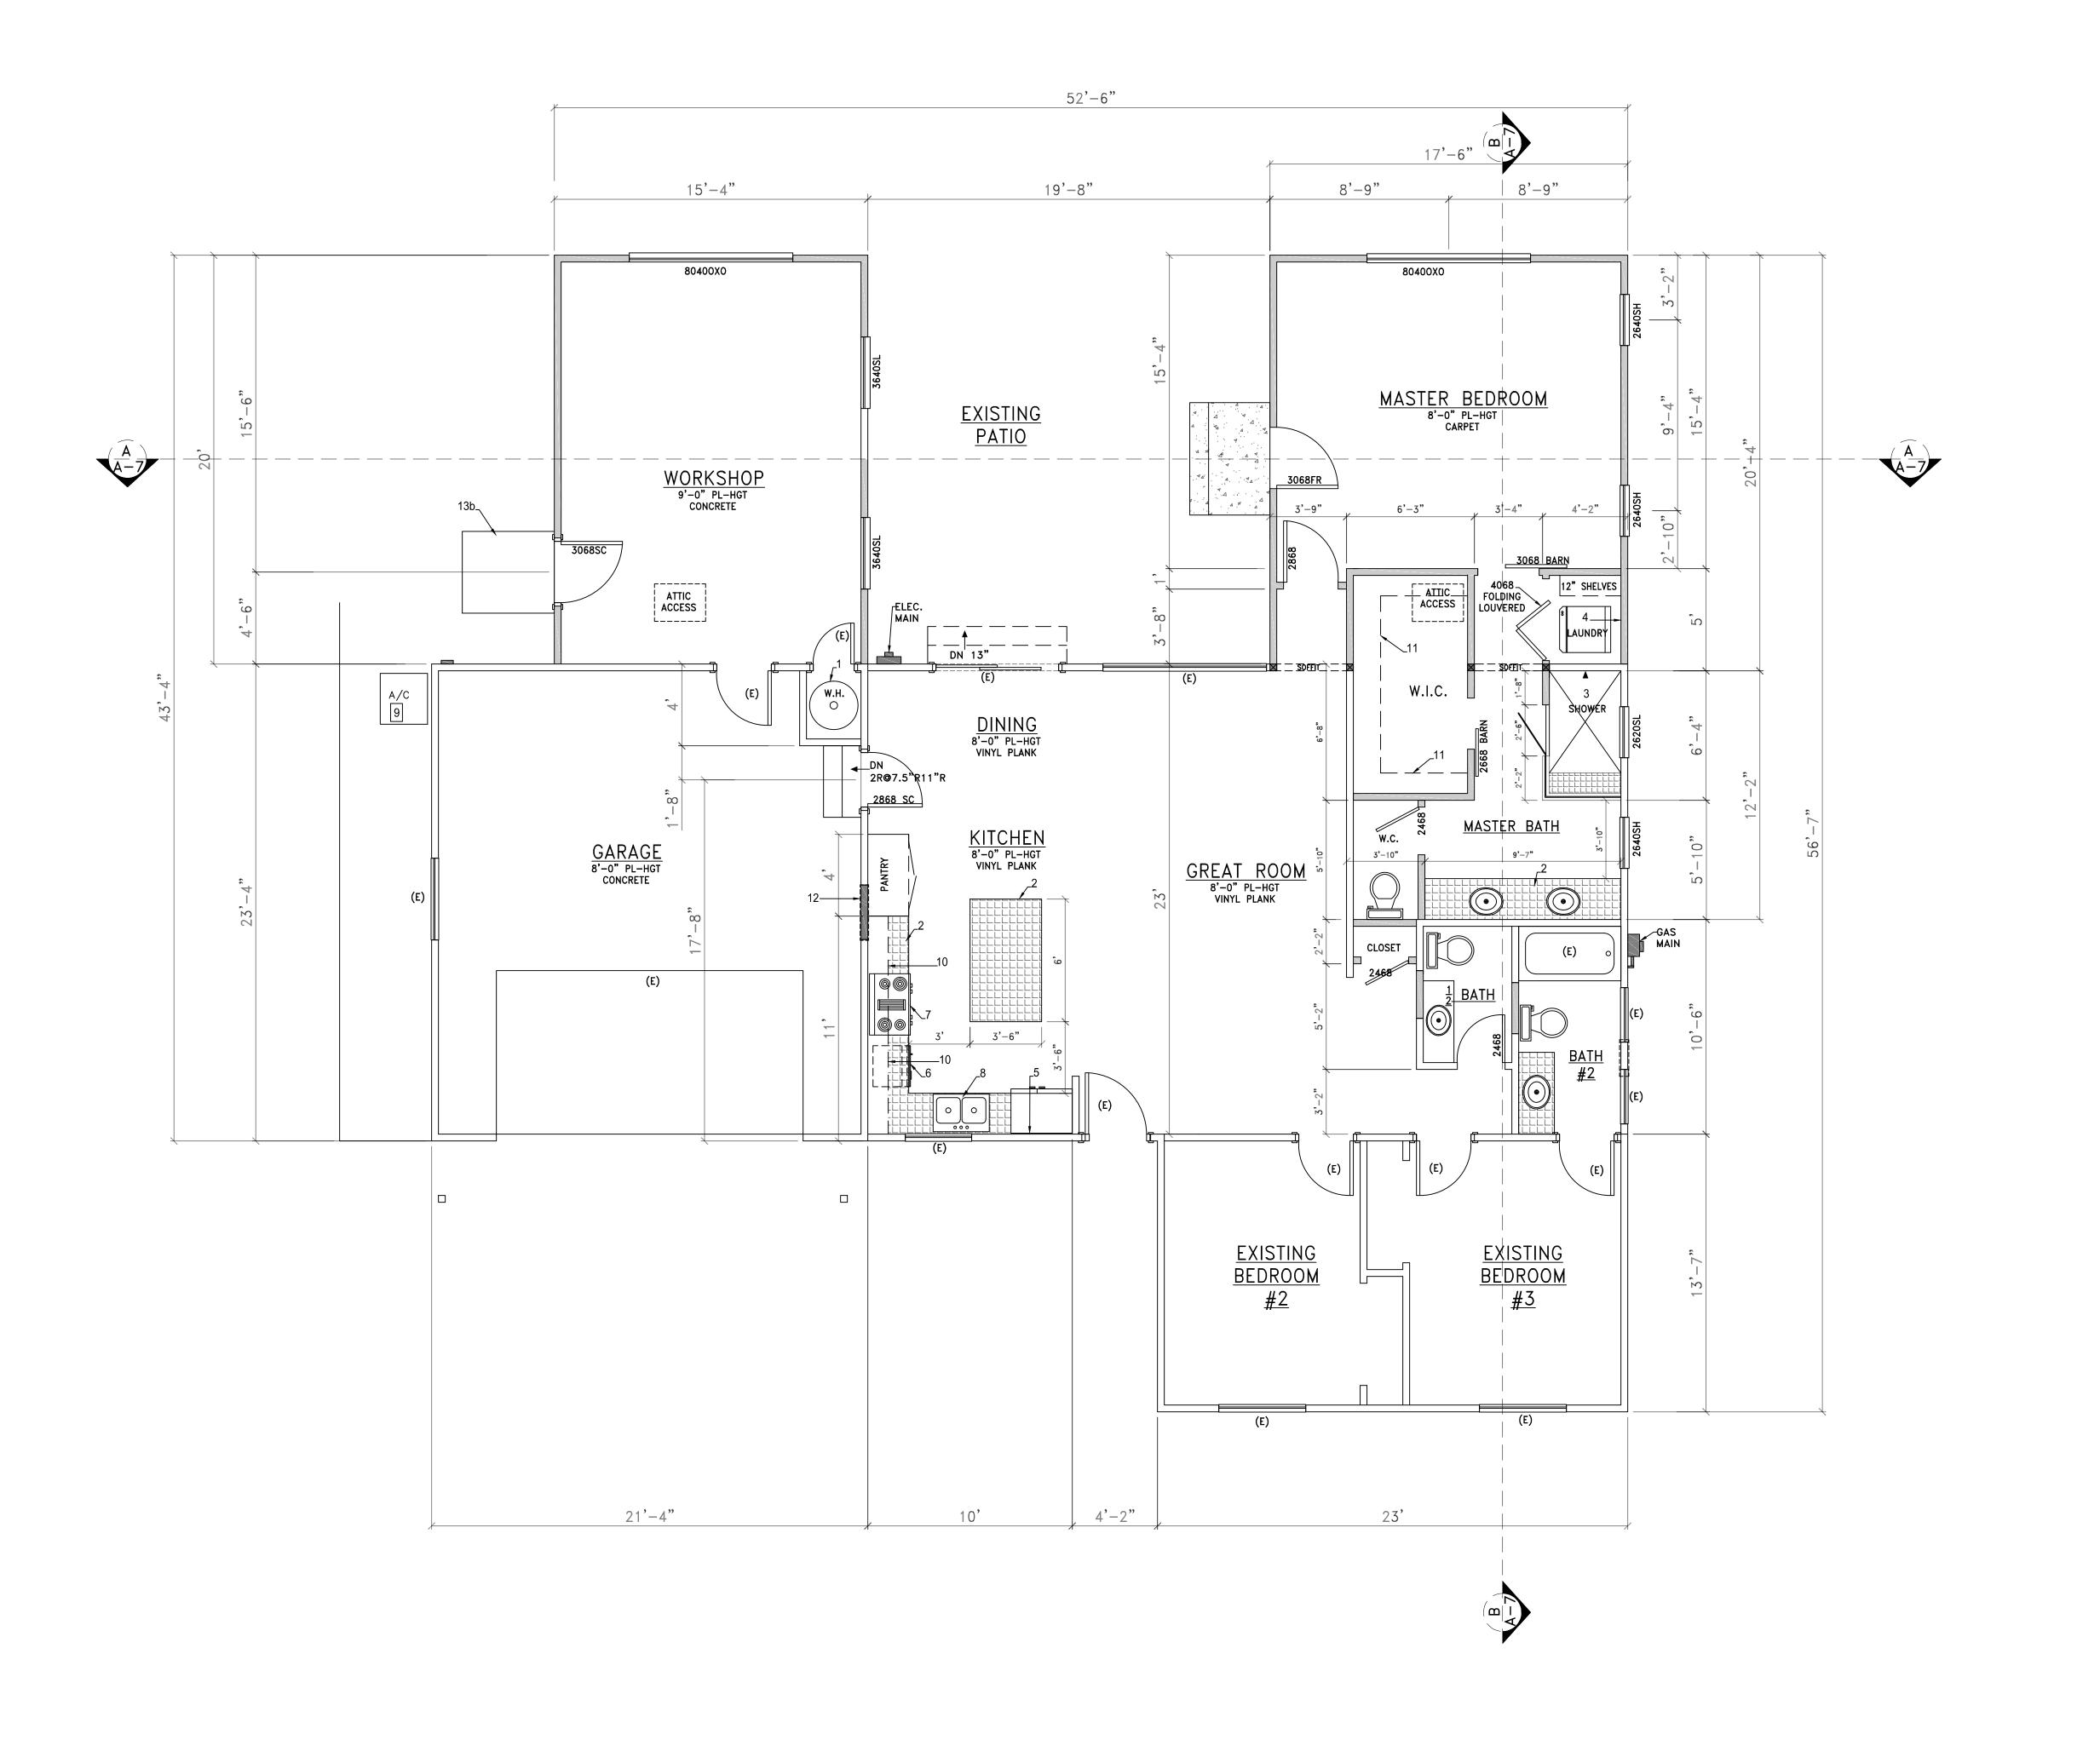

WALL LEGEND

EXISTING WALL FRAMING

NEW WALL FRAMING 2X4DF AT 16"O.C. W/ 2X BOTTOM & TOP PLATES 8'-0" PL-HGT R-13

KEY NOTES

- GAS WATER HEATER 50 GALLON
 ON 18" HIGH PLATFORM
 SEE ELEC. SHEET A-8 FOR GAS PIPING PLAN
 SEE ENERGY CALCS FOR EFFICIENCY DATA
- 2 COUNTERTOP FINISH a: TILE (BUILDER TO PROVIDE SPECS.) b: GRANITE (BUILDER TO PROVIDE SPECS.)
- SHOWER SURROUND TO 72" ABV. F.F. ENCLOSURE MUST BE OF APPROVED SAFETY GLAZING AND DOOR MUST SWING OUT OF SHOWER WDW IN TUB/SHOWER WALLS SHALL BE LABELED SAFETY GLAZING WHEN LESS THAN 60" ABV. THE DRAIN 6'-0" x 3'-6" SHOWER HOT MOP AND TILE WITH 12" DEEP BENCH SEAT
- | WASHER SPACE PROVIDE RECESSED WATER AND DRAIN DRYER SPACE W/DRYER VENT PER CURRENT CMC VENT TO OUTSIDE OF BUILDING
- 5 39" CLEAR REFRIGERATOR SPACE: (PROVIDE RECESSED STUB-OUT FOR ICE MAKER)
- 6 DISHWASHER (24"WIDE x 24"DEEP)
- SLIDE-IN RANGE/OVEN W/MICROWAVE & BUILT-IN HOOD, LIGHT AND FAN ABV. (VENT TO OUTSIDE AIR)
- B DOUBLE SINK W/ DISPOSAL
- 9 A/C UNIT ON PRECAST CONC. PAD (VERIFY PAD SIZE W/ UNIT MFR) SEE ENERGY CALCS FOR EFFICIENCY DATA.
- 10 LINE OF UPPER CABINET
- SHELF AND POLE (+ 66" A.F.F.)
- OCCUPANCY SEPARATION SEE GENERAL NOTE #7 SHEET
- CONC. STOOP BROOM FINISH (SLOPE AWAY FROM BUILDING) a: 36"x36" b: 42"x36"

SQUARE FOOTAGE SUMMARY

EXISTING DWELLING — GARAGE —

c: 72"x36"

1,196 SF 460 SF

REMODEL AREA -ADDITION -

SCALE: 1/4"= 1'-0"

716 SF

TOTAL CONDITIONED SQUARE FEET = 1,912 SF

VGNON SIGNON DESIGN

 \triangleleft

NOILION

 \triangleleft

30)-0000

 $C \stackrel{\cdot}{\otimes} C$

D 5(

AL C,

604 OLSC 071

Ž ∩


DESIGNED BY:


DRAWN BY: BT


3-17-22 PROJECT NO: 929

A-2.2

PROPOSED FLOOR PLAN

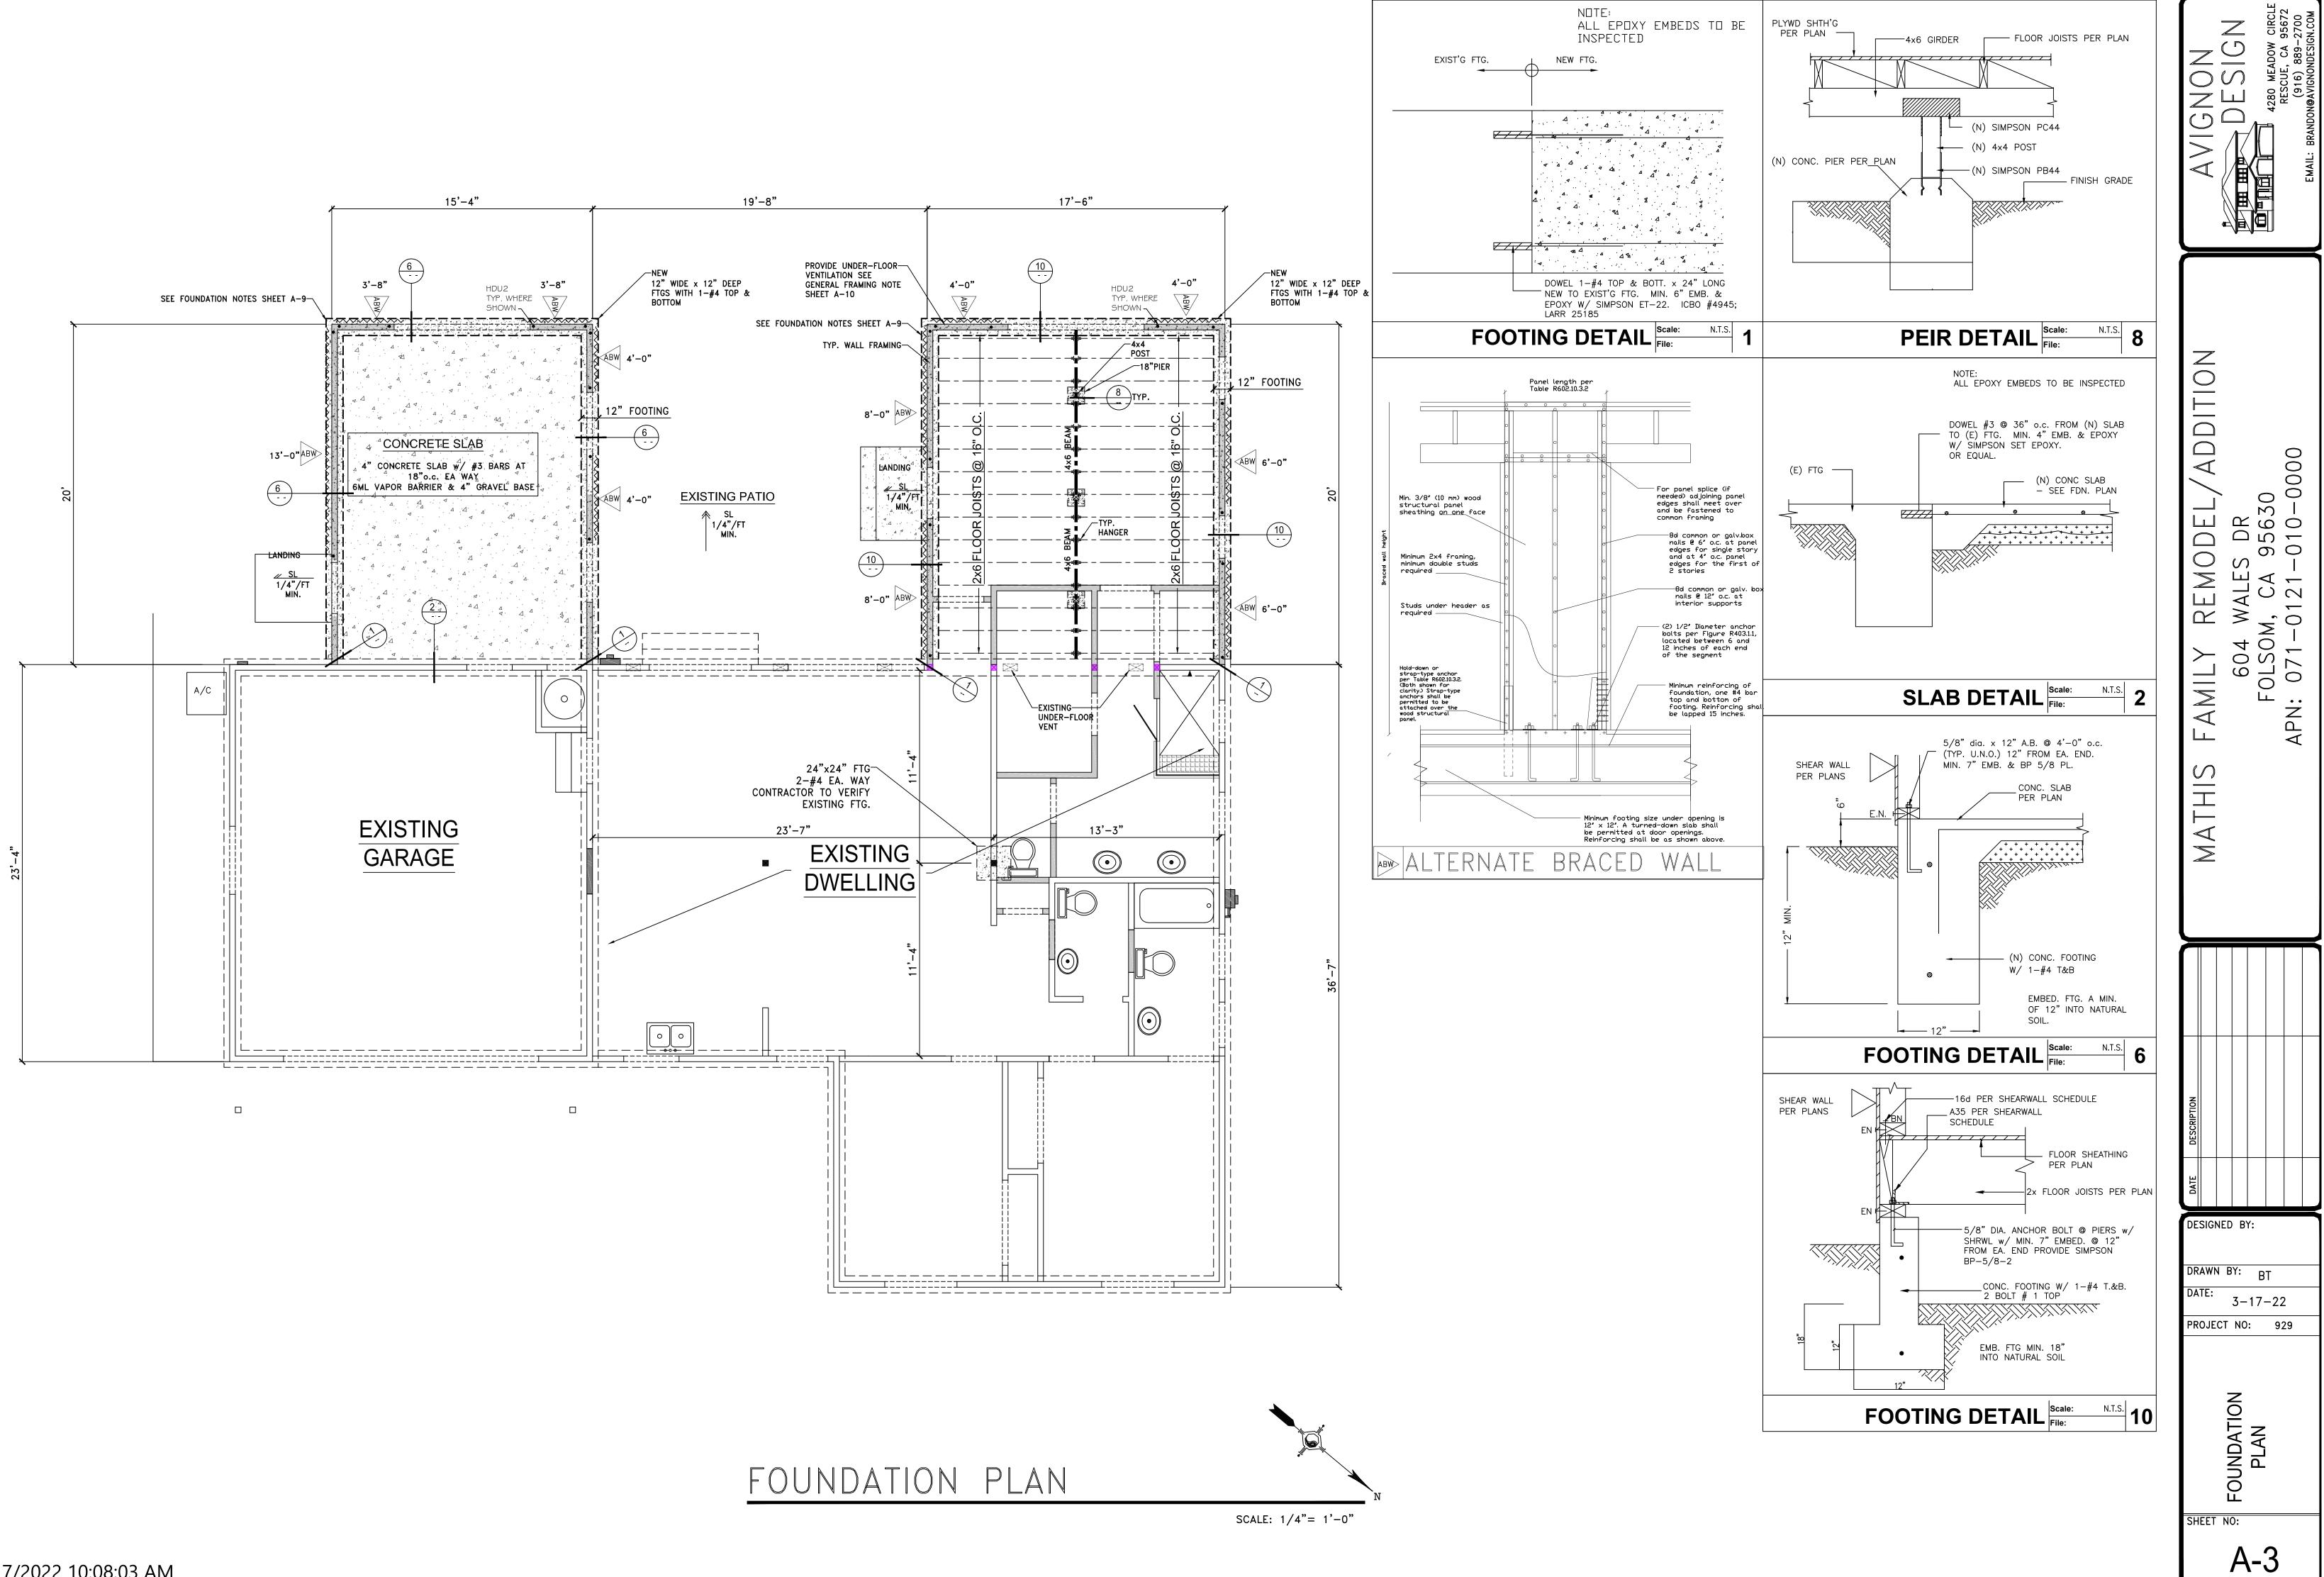


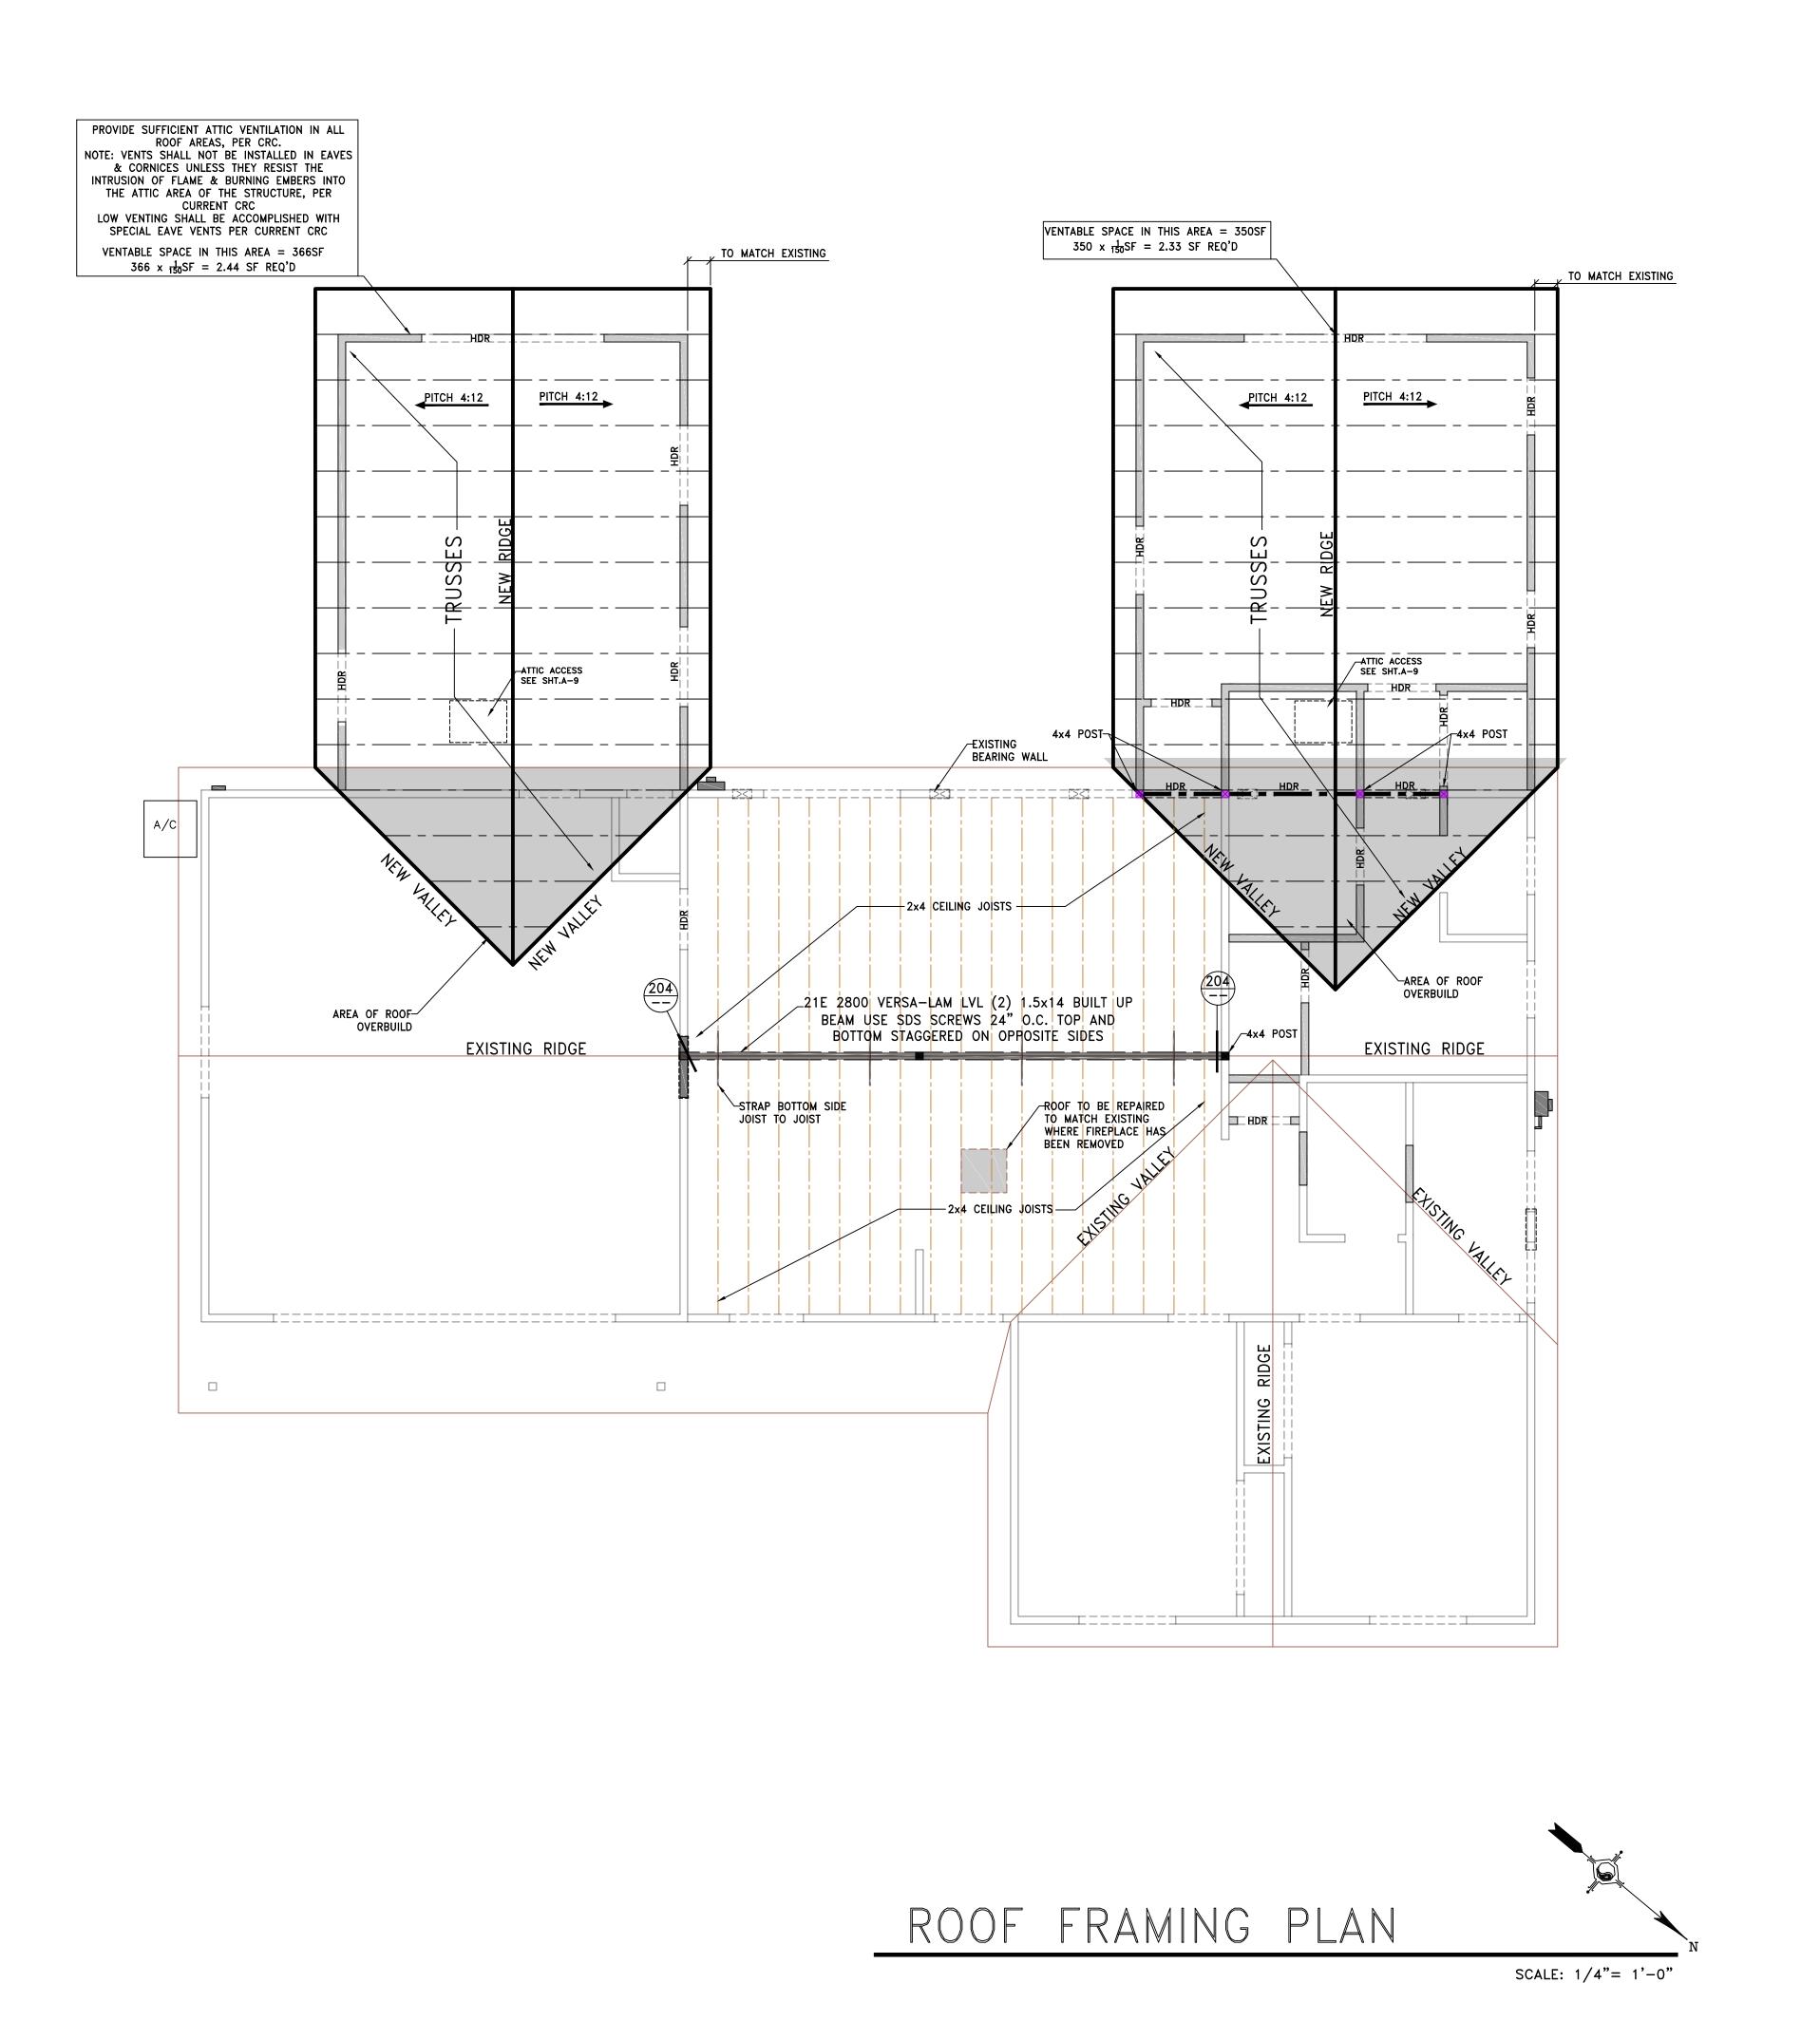

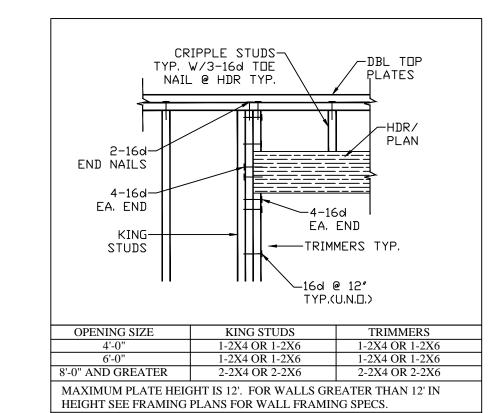

TYPICAL HEADER FRAMING DETAIL HEADER SCHEDULE

4'-0" MAX 4x8 #2 D.F.L. 6'-0" MAX 4x10 #2 D.F.L.

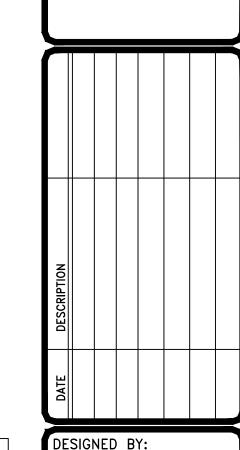

VIGNON


ADDITION


,30)-0000

DR 563

Ž ∩

604 OLSOP 071-

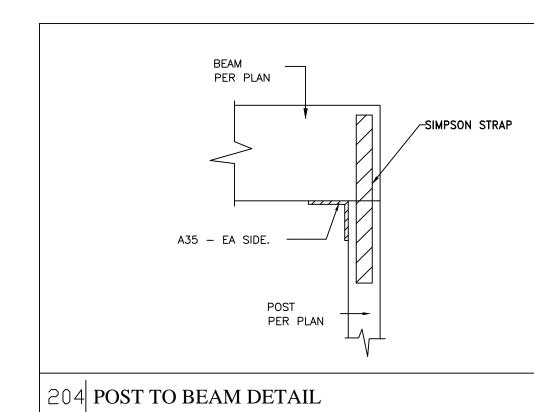

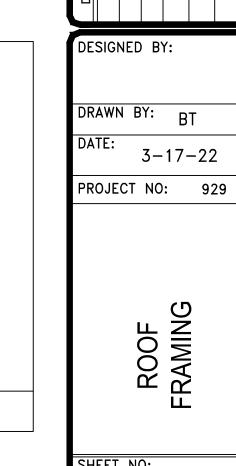

FAMILY REMODEL/ADDITION
604 WALES DR
FOLSOM, CA 95630
APN: 071-0121-010-0000

S NO

EXTERIOR ELEVATION

HEET NO:

PROVIDE DRIP EDGE FLASHING AT ALL EAVES
AND GABLES PER CRC R905,2.8.5
ADJACENT EDGES OF DRIP EDGE SHALL BE
OVERLAPPED

4" TRIM WINDOWS AND DOORS WHERE
SHOWN

SHOWN

SHOWN


WINDOWS AND DOORS WHERE
SHOWN

SHOWN

TO BE INSTALLED PER MANUFACTURES
SPECIFICATIONS BY AN INSTALLER CERTIFIED BY
MANUFACTURER AND SHALL COMPLY WITH
ASTM E 2588 2013 CRC R703.9.


<u>REAR ELEVATION - SOUTH WEST</u>

SCALE: 1/4"= 1'-0"

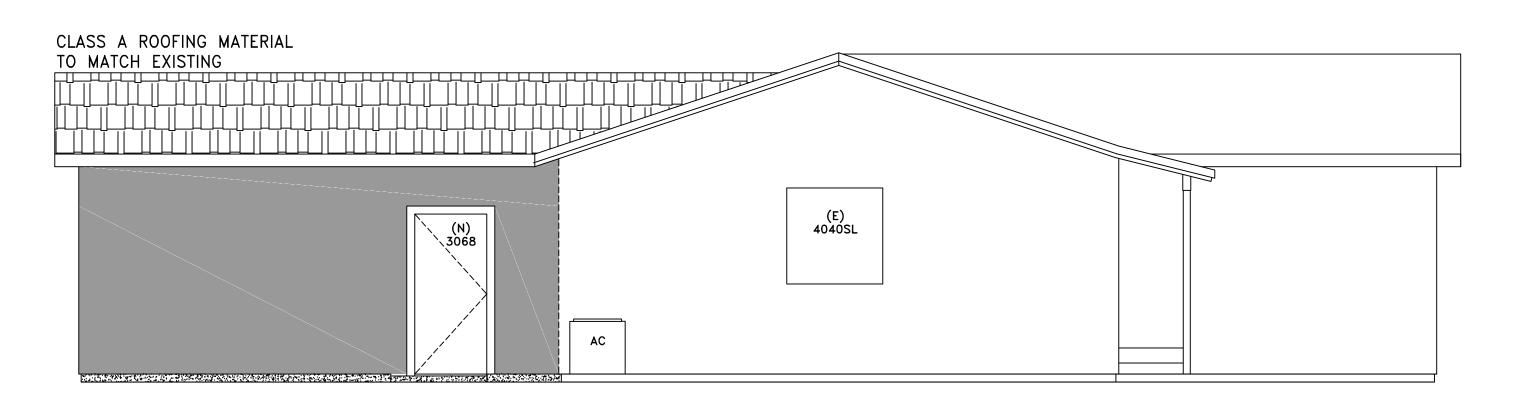

SIDE ELEVATION - SOUTH EAST

SCALE: 1/4"= 1'-0"

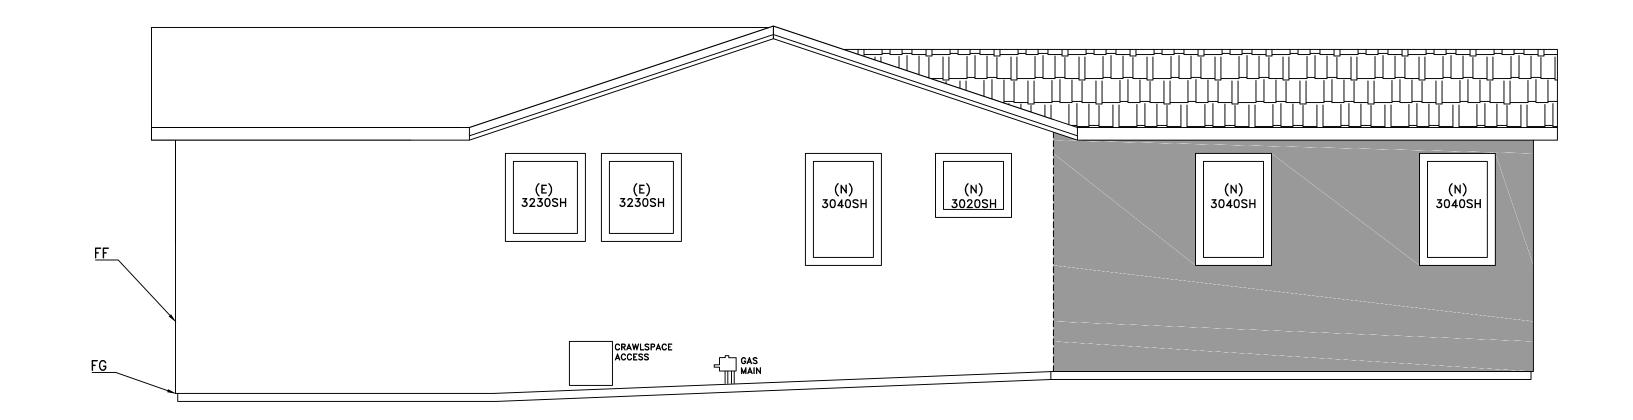


SIDE ELEVATION - NORTH WEST


SCALE: 1/4"= 1'-0"

IONS

SHEET NO:

A-7

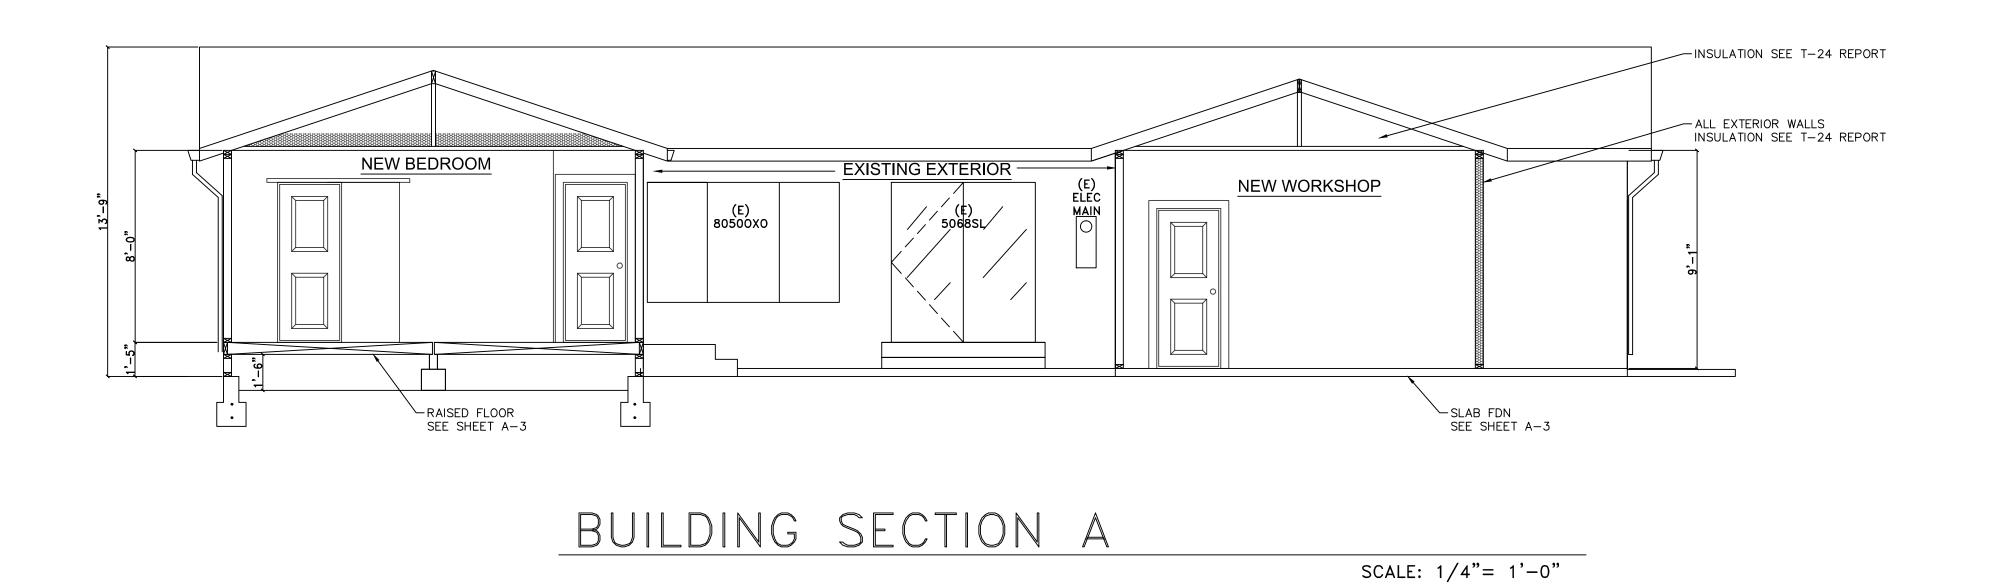

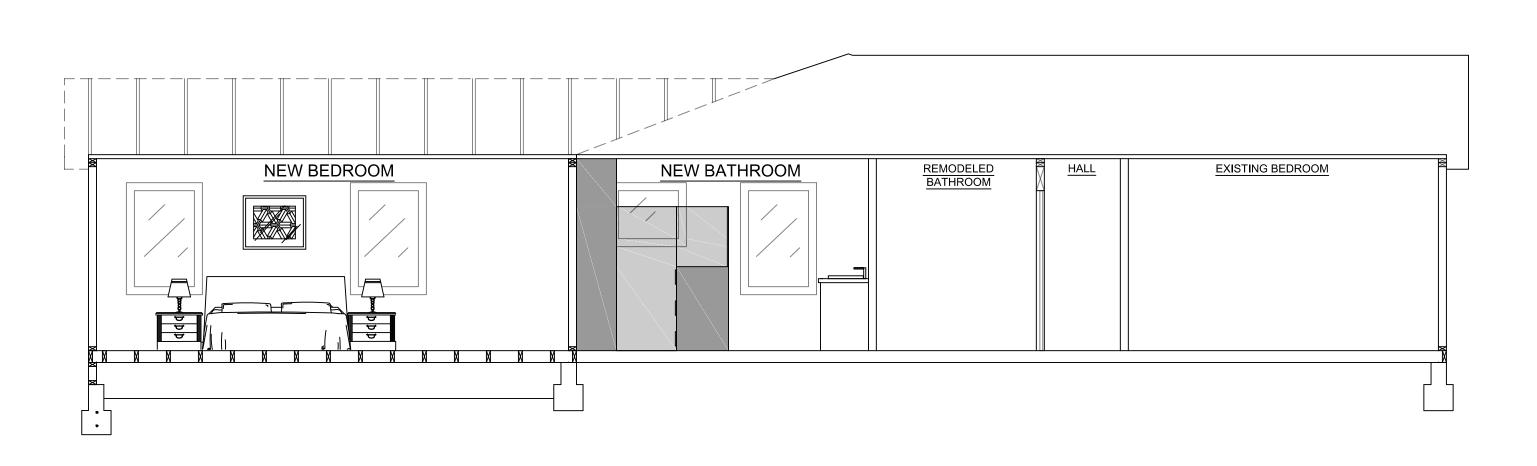

BUILDING SECTION B

SCALE: 1/4"= 1'-0"

ALL DOMESTIC HOT WATER SYSTEM PIPING CONDITIONS LISTED BELOW,

THE FIRST 5 FEET OF HOT AND COLD WATER PIPES FROM THE STORAGE TANK
 ALL PIPING WITH NOMINAL DIAMETER OF 3/4" OR LARGER

6. ALL HOT WATER PIPES FROM THE HEATING SOURCE TO THE KITCHEN FIXTURES.

4. PIPING FROM THE HEATING SOURCE TO STORAGE TANK OR BETWEEN TANKS.


OF PIPE DIAMETER.


5. PIPING BURIED BELOW GRADE.


WHETHER BURIED OR UNBURIED, MUST BE INSULATED PER TABLE 1210.3-A.

3. ALL PIPING ASSOCIATED WITH A DOMESTIC HOT WATER RETICULATION SYSTEM REGARDLESS




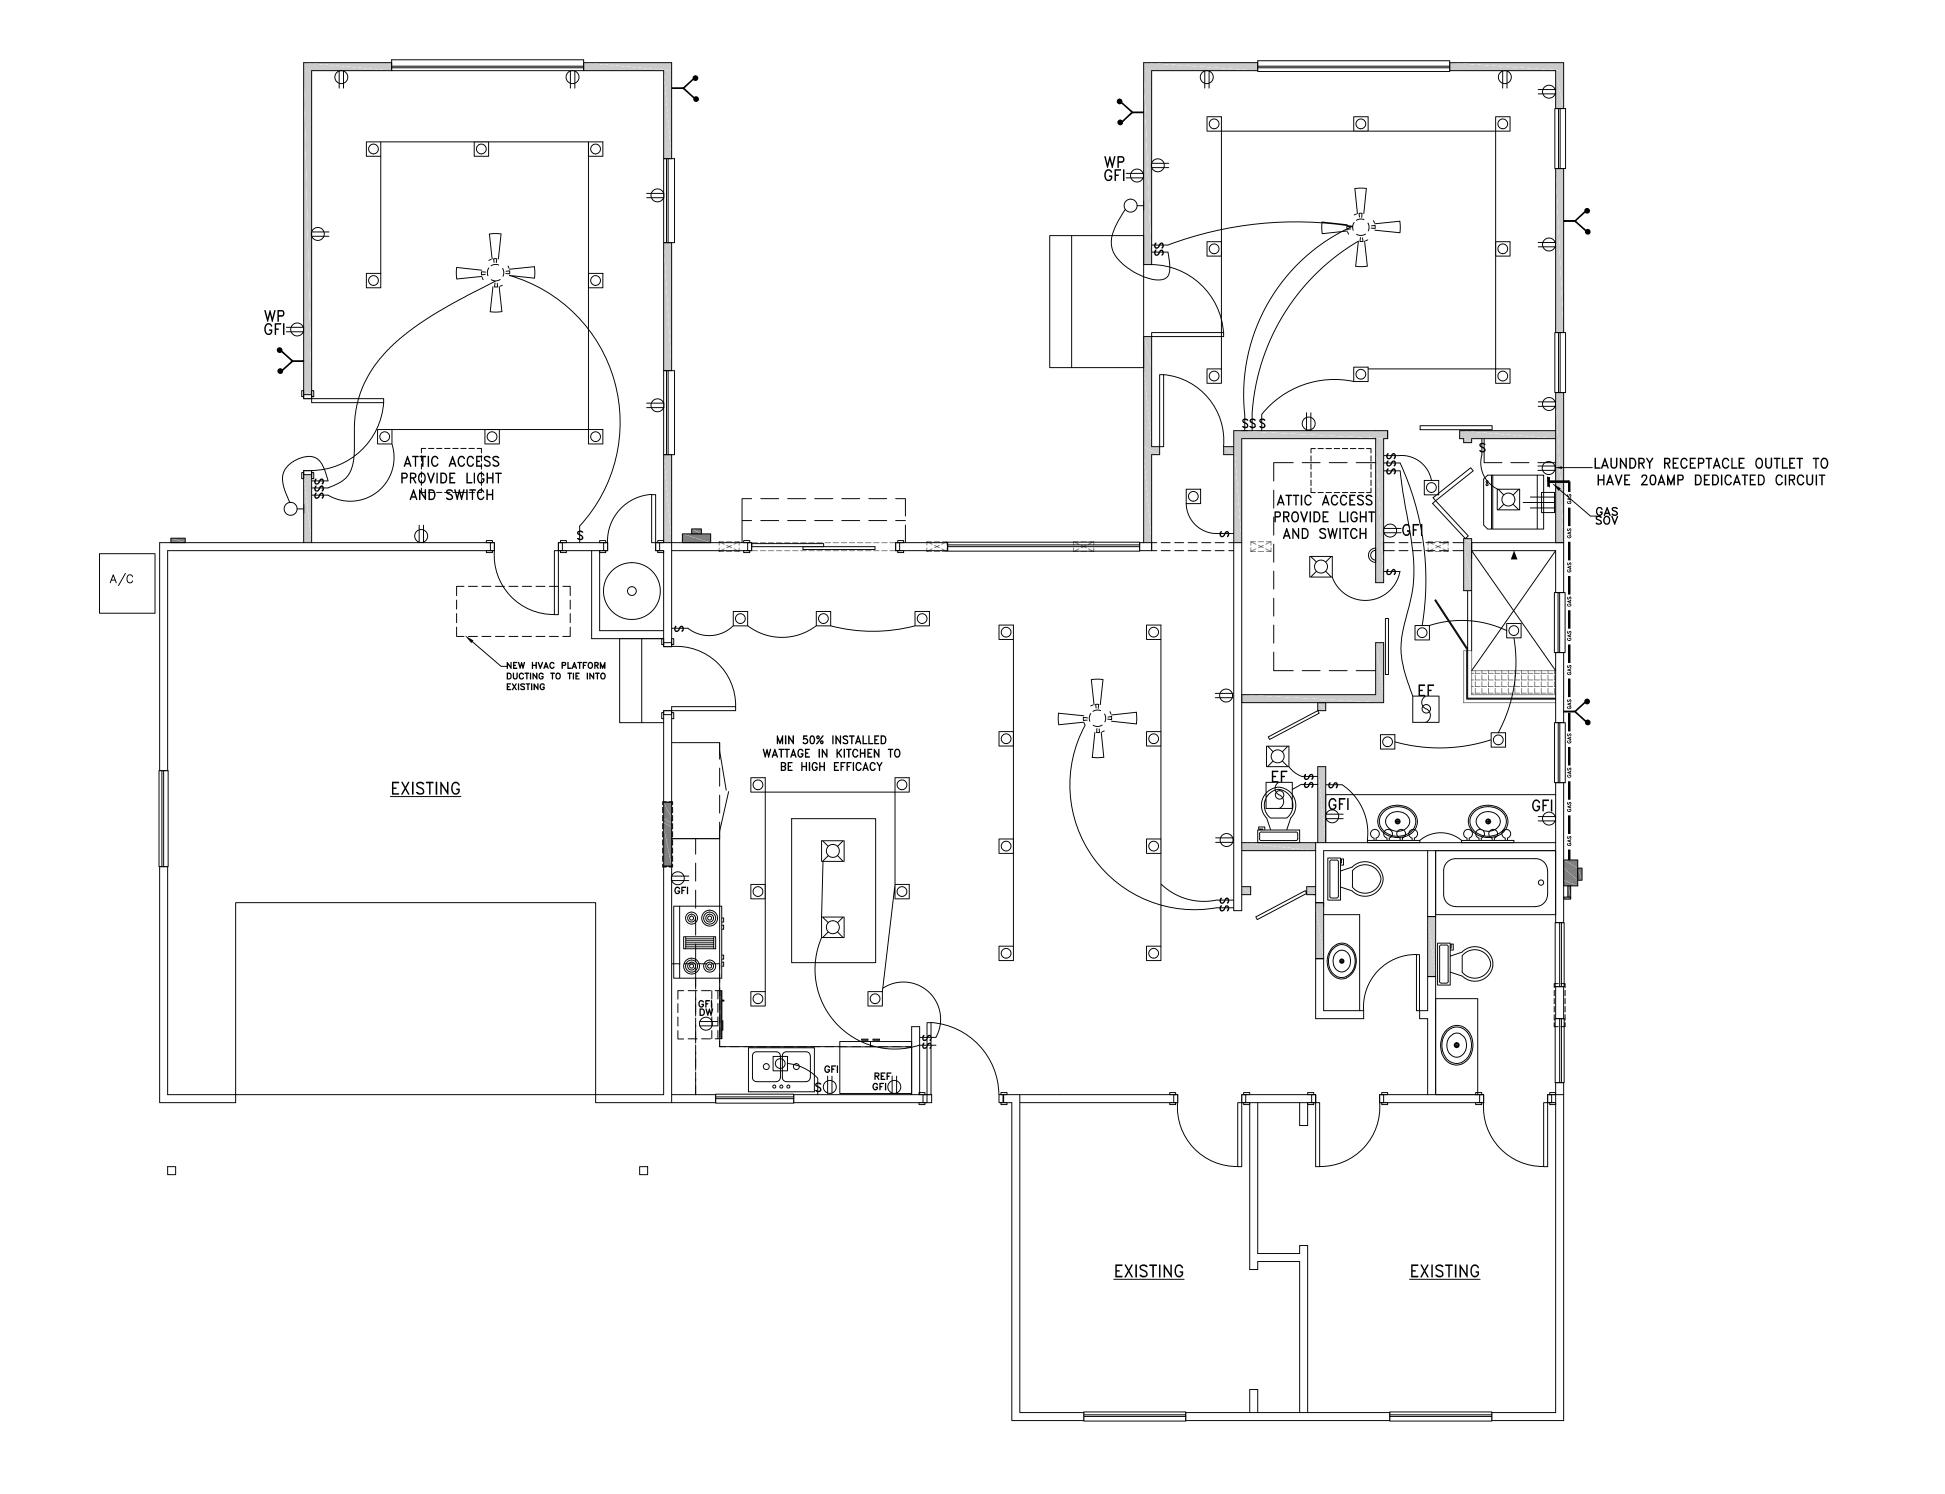

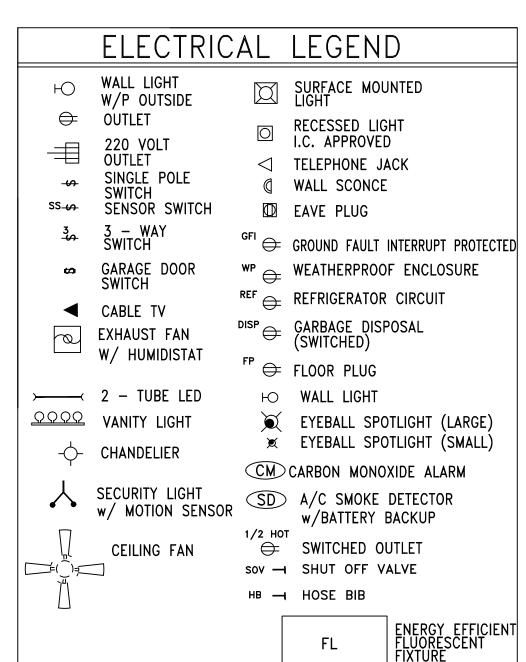

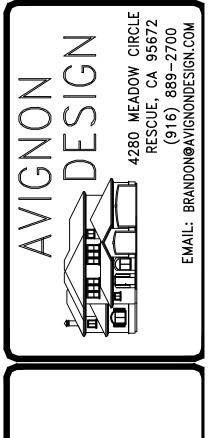

NOILION 000 \triangleleft 00 \sim 200 D 5(00 AL C, C Ž 0 60, 0LS(071 \triangleleft

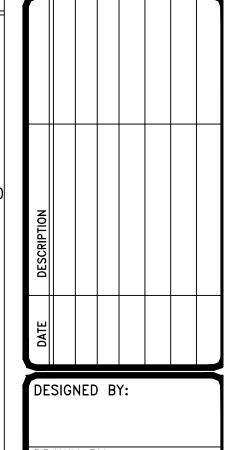

DRAWN BY: BT 3-17-22

PROJECT NO: 929 ELECTRICAL PLAN

SHEET NO:

GENERAL NOTES

1. EXTERIOR WALLS SHALL BE 2x4 STUDS AT 16"o.c. w/ MIN R-13 INSULATION U.N.O. SOLID FILL SHEATH ALL EXTERIOR WALLS WITH 3/8"OSB NAILED W/8d AT 6"o.c. EDGE 3/8" OSB NAILED W/8d AT 6"o.c. EDGE AND 12"o.c. FIELD. SHEATHING SHALL RUN CONTINUOUS FROM SOLE PLATE TO TOP PLATE WITH ALL EDGES BLOCKED.

2. WATER-RESISTANT GYPSUM BOARD SHALL NOT BE USED IN THE FOLLOWING LOCATIONS.

(A) OVER VAPOR RETARDER
(B) IN AREAS SUBJECT TO CONTINUOUS HIGH HUMIDITY

(C) ON CEILINGS

3. LANDINGS AT ALL EXTERIOR DOORS SHALL NOT BE LOWER THAN 1". LANDING SHALL BE A MIN. OF 36" IN DIRECTION OF TRAVEL. LANDING SHALL HAVE A WIDTH NOT LESS THAN WIDTH OF DOOR.

4. ONE HOUR SEPARATION REQUIRES A SELF-CLOSING AND SELF-LATCHING DOOR BETWEEN GARAGE AND DWELLING, WHERE DWELLING IS PROTECTED BY AN AUTOMATIC RESIDENTIAL FIRE SPRINKLER SYSTEM.

5. INTERIOR WALLS SHALL BE 2x4 DF U.N.O. USE 2x6 STUDS AT ALL UNSUPPORTED WALLS OVER 10' U.N.O.

6. EXTERIOR DOORS TO BE SOLID CORE & WEATHERSTRIPPED.

7. FOR DWELLING/GARAGE SEPARATION, PROVIDE 1/2" GYPSUM BOARD, OR EQUIVALENT, APPLIED TO GARAGE SIDE. WHERE LIVING AREAS OCCUR ABOVE, PROVIDE 5/8" TYPE "X" GYPSUM BOARD, OR EQUIVALENT.

8. PROVIDE 1/2" GYPSUM BOARD ON ALL ENCLOSED USABLE SPACE UNDER INTERIOR & EXTERIOR STAIRWAYS

8.a FIRE BLOCKING REQ'D TO PROVIDE SEPARATION BETW CONCEALED VERTICAL AND HORIZ SPACES. IN WALLS AT STAIR STRINGERS, AT SOFFITS, DROP CLGS, COVE CLGS, AT OPENINGS AROUND DUCTS VENTS, PIPES, & FLUE CHASES. FIRE BLKG SHALL BE PROVIDED VERTICALLY AT CLG & FLR LEVELS & HORIZONTALLY AT INTERVALS NOT EXCEEDING 10'

9. EACH SLEEPING AREA TO HAVE AT LEAST ONE POINT OF EMERGENCY EGRESS, PER CURRENT CRC. EGRESS WDWS TO HAVE MIN 5.7 SF OF OPENABLE AREA, WITH MIN HGT OF 24" AND MIN WIDTH OF 20". SILL HGT NOT TO EXCEED 44".

10. TOILET AREA TO HAVE CLEAR SPACE OF 30" MIN WIDTH AND MIN 24" CLEAR SPACE IN FRONT OF TOILET.

11. INSULATION MATERIAL, INCLUDING FACINGS SUCH AS VAPOR RETARDERS & VAPOR PERMEABLE MEMBRANES INSTALLED WITHIN FLR-CLG ASSEMBLIES. ROOF-CLG ASSEMBLIES. WALL ASSEMBLIES. CRAWLSPACES & ATTICS SHALL HAVE A FLAME SPREAD INDEX NOT TO EXCEED 25 WITH AN ACCOMPANYING SMOKE-DEVELOPED INDEX NOT TO EXCEED 450 WHEN TESTED IN ACCORDANCE W/ ASTM E 84 OR UL 723. WHEN MATERIALS ARE INSTALLED IN CONCEALED SPACES THE INDEXES DO NOT APPLY TO THE FACINGS WHEN FACING IS INSTALLED IN CONTACT W/ UNEXPOSED SURFACE OF CLG, FLR, OR WALL FINISH. CELLULOSE LOOSE-FILL INSULATION, NOT SPRAY APPLIED, SHALL ONLY BE REQ'D TO MEET SMOKE DEVELOPED INDEX OF MAX 450. SEE CRC R302.10.1 & R302.10.3

GENERAL FRAMING

1. PROVIDE BLOCKING FOR ALL FIXTURES, APPLIANCES, CABINETS OR OTHER ITEMS TO BE SECURED TO THE WALLS.

2. WOOD SHALL BE 8" MINIMUM ABOVE FINISH GRADE IF NOT TREATED.

3. CARRY UPPER LEVEL POSTS INTO LOWER LEVELS AND PROVIDE SOLID BLOCKING UNDER ALL POSTS IN FLOOR.

4. STUD SIZE, HGT, LENGTH, SPACING SHALL CONFORM WITH CURRENT CBC.

5. LUMBER IN CONTACT WITH OR WITHIN 1-1/2" OF CONCRETE SHALL BE FOUNDATION GRADE REDWOOD OR PRESSURE TREATED DOUGLAS FIR.

6. CAULK BETWEEN SOLE PLATES AND FLOOR SHEATHING.

7. DOUBLE STUDS OR 4x POSTS UNDER ENDS OF ALL BEAMS AND HEADERS, U.N.O.

8. EXTERIOR WALLS TO BE 2x4 STUDS AT 16"o.c.

9. PROVIDE MIN 22"x 30" ATTIC ACCESS OPENING IN READILY ACCESSIBLE LOCATION. THIRTY INCH MIN UNOBSTRUCTED HEADROOM IN ATTIC SPACE SHALL BE PROVIDED

AT OR ABOVE THE ACCESS OPENING.

10. INTERIOR WALLS (U.N.O.) - 1/2"G.W.B. WITH 5d DRYWALL NAILS AT 7"o.c. AT ALL PLATES, BLOCKING AND STUDS (USE 6d DRYWALL NAILS AND 3/4" G.W.B.).

11. USE HOT-DIPPED GALVANIZED IRON NAILS FOR ALL EXTERIOR NAILING.

12. NOT USED

13. ALL HEADERS OVER LOAD BEARING WALL OPENINGS SHALL BE PER ENGINEERING. SEE FRAMING PLANS.

14. NOT USED

15. BEARING PARTITIONS, PERPENDICULAR TO JOISTS, SHALL NOT BE OFFSET FROM SUPPORTING GIRDERS, BEAMS, WALLS OR PARTITIONS MORE THAN THE DEPTH OF THE JOIST.

16. UNDER-FLOOR VENTILATION TO HAVE NET AREA OF NOT LESS THAN 1 SF PER 150SF OF FLOOR AREA. OPENINGS LOCATED AS CLOSE TO CORNERS AS POSSIBLE. OPENINGS TO BE EQUALLY DISTRIBUTED ALONG LENGTH OF AT LEAST TWO OPPOSITE SIDES. COVERED WITH CORROSION-RESISTANT WIRE MESH WITH MESH OPENINGS OF 1/4" IN DIMENSION.

17. SHIM POSTS AND COLUMN CAPS AS REQUIRED FOR GLULAM AND LAMINATED BEAMS WITH SOLID LUMBER.

FOUNDATION

FOOTING DEPTHS GIVEN INTO APPROVED COMPETENT SOIL

2. SLOPE FINISH GRADE AWAY FROM STRUCTURE AND ALL ISOLATED FOOTINGS. PONDING OF WATER NOT PERMITTED.

3. TOP OF ALL FOOTINGS TO BE 8" MINIMUM ABOVE FINISHED GRADE

4. SAND FILL TO BE MOIST.

5. ALL FILL AND BACKFILL TO BE COMPACTED TO AT LEAST 90% OF RELATIVE COMPACTION AT OPTIMUM MOISTURE CONTENT IN ACCORDANCE

6. PRIOR TO PLACING CONCRETE, VERIFY LOCATION AND SECURE IN POSITION ALL REINFORCING STEEL, DOWELS, METAL, ANCHORS, STRAPS, HOLDOWNS, POST AND COLUMN BASES TO BE EMBEDDED IN CONCRETE

7. "HD" HOLDOWNS TO BE AS MANUFACTURED BY "SIMPSON". SIZE AND INSTALLATION PER MANUFACTURER'S RECOMMENDATIONS. VERIFY

EXACT LOCATION. 8. USE 5/8" OR 1/2" DIAMETER ANCHOR BOLTS AT EXTERIOR WALLS AND WHERE SHOWN ON FOUNDATION PLAN. ANCHOR BOLTS TO BE LOCATED 12" FROM CORNERS, 4'-0" o.c.

MAX, TYPICAL, U.N.O. (SEE FLOOR PLAN). TO BE MIN 7" EMBEDMENT INTO CONCRETE. USE 3"x3"x.229" WASHER AT EA ANCHOR BOLT. 9. VAPOR BARRIER TO BE 6-MIL POLYETHYLENE FOR CONCRETE SLABS. SEAL ALL JOINTS OR LAP 12" MIN. TAKE CARE TO PREVENT DAMAGE

10. LOT SHALL BE GRADED TO DRAIN SURFACE WATER AWAY FROM FDN WALLS. GRADE SHALL FALL A MIN OF 6" WITHIN FIRST 10'. EXCEPTION: WHERE LOT LINE, WALLS, SLOPES OR OTHER PHYSICAL BARRIERS PROHIBIT 6" OF FALL WITHIN 10', DRAINS OR SWALES SHALL BE CONSTRUCTED

ROOF FRAMING

1. IN OPEN BEAM CONSTRUCTION, USE RIDGE TIE-STRAPS.

TO ENSURE DRAINAGE AWAY FROM STRUCTURE.

ROOF SHEATHING OVER 2x RAFTERS 1/2" CDX STRUCTURAL i EXPOSURE 1, APA, FACE GRAIN TO BE PERPENDICULAR TO SUPPORTS. NAIL 8d AT 6"o.c. EDGES, RIDGES, RAKES AND EAVE BLOCKING. NAIL 12" o.c. FIELD.

ROOF DECKING OVER EXPOSED BEAMS - DOUGLAS FIR 2x6 V-GROOVE T&G SHEATHING WITH 2-20d NAILS AT EACH POINT OF SUPPORT PER BOARD PRE-DRILLED THROUGH RAFTER.

4. USE H1 OR A35 JOIST TO PLATE TYPE CONNECTOR AT EACH TRUSS OR RAFTER END BEARING.

5. TRUSSES SHALL NOT BEAR ON ANY INTERIOR WALLS OR PARTITIONS NOT SHOWN ON TRUSS CALCULATIONS. USE DTC ROOF TRUSS CLIPS WITH A 1/2" SPACE BETWEEN BOTTOM CHORD AND TOP PLATE.

6. USE TYP 15 FELT UNDERLAYMENT FOR COMPOSITION ROOF COVERING. USE TYPE 30 FELT UNDERLAYMENT FOR TILE ROOFS.

1. PROVIDE AN APPROVED DISHWASHER AIR GAP FITTING AS PER CPC.

PLUMBING NOTES

2. CERAMIC TILE SHOWER & TUB/SHOWER WALLS TO HAVE SMOOTH, HARD NONABSORBENT WATER RESISTANT SURFACE TO A HGT OF 70" ABOVE DRAIN INLET. GYP BD MUST HAVE WATER RESISTANT GYPSUM BACKING BD. WATER-RESISTANT GYP BACKING BD SHALL NOT BE USED ON CLG FRAMING SPACED MORE THAN 12"o.c.

INSTALL SEALING MEMBRANE OVER WATER RESISTANT GYPSUM BACKING 3. ALL PLUMBING PENETRATIONS THROUGH A FIRE WALL ASSEMBLY

SHALL BE OF CAST IRON, INCLUDING TRAP. 4. INSTALL WATER CLOSET CAPABLE OF COMPLYING WITH MAXIMUM

1.6 GALLONS PER FLUSH. 5. PROVIDE AND INSTALL 4" MAIN WASTE LINE.

6. PROVIDE APPROVED NON-REMOVABLE BACKFLOW DEVICES AT ALL HOSE BIBS AND SPRINKLER SYSTEMS, PER CURRENT CODE.

WATER HEATER(S) SHALL BE PLACED ON 30"x36" WOOD FRAMED EQUIPMENT PLATFORM 18" ABOVE FLOOR SURFACE. SEISMIC STRAPS (TWO) AT WATER HEATER AT POINTS W/IN THE UPPER 1/3 AND LOWER 1/3 OF ITS VERTICAL DIMENSION.

LOWER STRAP AT MIN DISTANCE OF 4" ABV CONTROLS. PER CURRENT PLUMBING CODE

WATER HEATER(S) SHALL BE PROVIDED WITH COMBINATION PRESSURE AND TEMPERATURE RELIEF VALVE. PROVIDE DRAIN TO COMPLY WITH CPC. WATER HEATER VENT SHALL NOT TERMINATE LESS THAN 5' ABOVE VENT COLLAR. PROVIDE BOLLARD IN FRONT OF WATER HEATER WHERE APPLICABLE. DOOR SERVING WATER HEATER SHALL BE MIN OF 24" WIDE OR WIDE ENOUGH TO ALLOW REMOVAL OF WATER HEATER. WATER HEATERS IN GARAGE MUST HAVE PILOTS, BURNERS OR HEATING ELEMENTS & SWITCHES

AT LEAST 18" ABOVE THE FLOOR. PER CURRENT PLUMBING CODE 9. SHOWER CONTROL VALVE ASSEMBLY TO COMPLY WITH CURRENT PLUMBING CODE. PRESSURE BALANCE OR THERMOSTATIC MIXING VALVE TYPE. MAXIMUM WATER TEMPERATURE SETTING TO BE 120 DEGREES.

10. SHUT OFF VALVES SHALL BE INSTALLED IN FUEL SUPPLY PIPING OUTSIDE EA APPLIANCE. SHUT OFF VALVE SHALL BE WITHIN 3' OF APPLIANCE IT SERVES & IN SAME RM OR SPACE WHERE APPLIANCE IS LOCATED. PER CURRENT PLUMBING CODE

11. RELIEF VALVES LOCATED INSIDE BLDG SHALL BE PROVIDED WITH DRAIN OF GALVANIZED STEEL, HARD DRAWN COPPER PIPING & FITTINGS, CPVC, OR LISTED VALVE DRAIN. PER CURRENT PLUMBING CODE

12. WATER USE RATES OF ALL PLUMBING FIXTURES SHALL BE IN COMPLIANCE WITH WATER CONSERVATION REQUIREMENTS OF CALGREEN.

GLAZING NOTES

ALL GLAZING MATERIAL USED IN WINDOWS, DOORS, DOOR SIDELIGHTS, SLIDING GLASS DOORS, SHOWER DOORS, AND MIRRORED WARDROBE DOORS, ETC., SHALL COMPLY WITH GLASS AND GLAZING STDS, AS DEFINED BY CURRENT CRC SAFETY GLAZING IS REQ'D PER CURRENT CRC

2. PROVIDE SAFETY GLAZING AT HAZARDOUS LOCATIONS-SUCH AS WINDOWS ADJACENT TO TUBS, SHOWERS, TUB/SHOWERS, ADJACENT TO AND WITHIN 24" OF EITHER EDGE OF DOOR.

3. PROVIDE SAFETY GLAZING AT DOORS AND PANELS OF SHOWER AND BATH TUB ENCLOSURES AND ADJACENT WALL OPENINGS WITHIN

60" ABOVE A STANDING SURFACE AND DRAIN INLET. 4. EGRESS WINDOWS TO HAVE A MAXIMUM SILL HEIGHT OF 44" ABV FLOOR. ELECTRICAL NOTES

INSTALL 110v. SMOKE DETECTORS WITH BATTERY BACK-UP, WHICH ARE AUDIBLE IN ALL SLEEPING AREAS AT ALL BEDROOMS, HALLWAYS LEADING TO BEDROOMS, ABOVE STAIRS AND AT LEAST ONE ON

EVERY LEVEL. TO RECEIVE THEIR PRIMARY POWER FROM BLDG WIRING. TO EMIT SIGNAL WHEN BATTERIES ARE LOW. WIRING SHALL BE PERMANENT & W/O A DISCONNECTING SWITCH OTHER THAN AS REQ'D FOR OVERCURRENT PROTECTION.

SMOKE DETECTORS SHALL BE INTERCONNECTED SUCH THAT THE ACTIVATION OF ONE ALARM WILL ACTIVATE ALL ALARMS. THE ALARM SHALL BE CLEARLY AUDIBLE

INSTALL ELECTRICAL PANEL PER CEC AND ELECTRIC AND GAS SERVICE REQUIREMENTS "GREEN BOOK".

LIGHTING FIXTURES IN BATH AND KITCHEN SHALL BE OF EFFICACY OF AT LEAST 40 LUMENS PER WATT. PROVIDE INSULATION COVER FOR

PROVIDE FUSES OR APPROVED CIRCUIT BREAKER AT A/C UNIT(S). THE DISCONNECTING MEANS FOR

A/C UNITS MUST NOT BE ON THE EXTERIOR OF THE DISCONNECT BOX. OUTLET BOXES SHALL NOT BE SOLE SUPPORT FOR CLG FANS. A FIXTURE THAT WEIGHS MORE THAN 6# OR EXCEEDS 16" IN ANY DIM SHALL NOT BE SUPPORTED BY SCREW SHELL OF LAMP HOLDER.

DIMMER SWITCHES MAY ONLY BE USED FOR PERMANENT FIXTURES.

RECESSED LIGHT FIXTURES LOCATED W/IN INSULATED ATTIC SHALL BE I.C. RATED FIXTURES.

8. SMALL APPLIANCE CIRCUITS SHALL NOT SUPPLY DISPOSAL, DISHWASHER OR OTHER LARGE APPLIANCES PER CEC.

BATHROOM RECEPTACLES SHALL BE SUPPLIED w/ A SEPARATE 20A CIRCUIT AND SHALL NOT HAVE LIGHTING, EXHAUST FANS OR OTHER OUTLETS ON IT PER NEC 210-52(d). PROVIDE TWO OR MORE 20A SMALL APPLIANCE BRANCH CIRCUITS IN KITCHEN, PANTRY, NOOK, AND DINING AREAS. TO HAVE NO OTHER OUTLETS.

10. PROVIDE A GROUNDING ELECTRODE AS PER CURRENT CEC.

PROVIDE 30"x30" SQUARE ATTIC ACCESS FOR FAU UNIT LOCATED IN ATTIC. PROVIDE 24" WIDE PLATFORM PATH FROM ACCESS OPENING TO FAU. PROVIDE ELECTRICAL OUTLET AND SWITCH AT ACCESS OPENING. PROVIDE ATTIC LIGHT FIXTURE AT LOCATION OF FAU.

12. BRANCH CIRCUITS SUPPLYING OUTLETS ARE REQ'D TO BE AFCI EQUIPPED AT FAMILY ROOMS DINING ROOMS, LIVING ROOMS, BEDROOMS, GAMES ROOMS, CLOSETS, HALLWAYS, AND SIMILAR ROOMS. PER CEC 210.12

13. RANGES, OVENS & DRYERS SHALL BE ON 4-WIRE RECEPTACLES.

14. INCANDESCENT LIGHTS IN CLOSETS TO BE MIN 12" FROM NEAREST POINT OF STORAGE

AREA ON SHELF IN CLOSET. 15. ALL 125-VOLT, 15 AMP, AND 20 AMP RECEPTACLES TO BE LISTED AS TAMPER RESISTANT PER CEC 406.11

MECHANICAL NOTES

1. DRYER TO BE EQUIPPED WITH SMOOTH METAL DUCT EXTENDING TO OUTSIDE OF BLDG. TO BE EQUIPPED WITH BACKDRAFT DAMPER. NOT TO EXCEED A COMBINED HORIZONTAL AND VERTICAL LENGTH OF 14LF, INCLUDING TWO 90° ELBOWS.

2. RESIDENCE SHALL BE PROVIDED WITH HEATING FACILITIES CAPABLE OF MAINTAINING A ROOM TEMPERATURE OF 68 DEGREES F AT A POINT 3' ABOVE FLOOR.

3. WHERE NATURAL VENTILATION IS NOT PROVIDED INSTALL A MECHANICAL VENTILATION SYSTEM CAPABLE OF PROVIDING FIVE (5) AIR CHANGES

EXHAUST FAN SYSTEMS SHALL HAVE BACKDRAFT OR AUTOMATIC DAMPERS AND BE INSULATED PER CURRENT CODE.

FAU EQUIPMENT SHALL BE PLACED ON EQUIPMENT PLATFORM 18" ABV FLR SURFACE. FAU TO BE NO MORE THAN 20' FROM ATTIC ACCESS. PASSAGEWAY SHALL BE UNOBSTRUCTED & SHALL HAVE CONTINUOUS SOLID FLOORING 24" WIDE, MIN. EQUIPMENT PLATFORM TO BE A LEVEL WORKING SURFACE OF 30" IN DEPTH IN FRONT OF THE ENTIRE FIREBOX SIDE. PRE-MANUFACTURED FLEXIBLE AIR DUCTS TO BE INSTALLED ACCORDING TO INSTALLATION INSTRUCTIONS & STDS PER CODE & INSTALLED USING UL 181B TAPE.

6. B-VENTS WITH LISTED VENT CAPS 12" OR LESS SHALL TERMINATED IN ACCORDANCE WITH CMC. THEY SHALL BE LOCATED AT LEAST 8' FROM VERTICAL WALL OR SIM OBSTRUCTION. ALL OTHER B-VENTS SHALL TERMINATE AT LEAST 2' ABOVE HIGHEST PT OF ANY PART OF BLDG WITHIN 10'.

EACH BATHROOM (ANY RM CONTAINING A BATHTUB, SHOWER, SPA, OR SIM SOURCE OF MOISTURE) IS REQ'D TO HAVE A DEDICATED EXHAUST FAN DUCTED TO OUTSIDE. IF EQUIPPED W/ INTERMITTENT OPERATED EXHAUST FAN MIN VENTILATION SHALL BE 50CFM. IF EQUIPPED W/ CONTINOUS OPERATED EXHAUST FAN. SHALL OPERATE AT MIN VENTILATION RATE OF 20CFM. EXHAUST FAN SHALL BE OPERATED OCCUPANT, ACCESSIBLE, & OBVIOUS. EX: WALL SWITCH OR OCCUPANCY SENSOR. FAN CONTROL MUST BE LABELED AS TO ITS FUNCTION.

8. EACH KITCHEN (ANY RM CONTAINING COOKING APLIANCES) IS REQ'D TO HAVE A DEDICATED EXHAUST FAN DUCTED TO THE OUTSIDE. IF EQUIPPED W/ INTERMITTENT OPERATED EXHAUST FAN MIN VENTILATION SHALL BE 100CFM. IF EQUIPPED W/ CONTINOUS OPERATED EXHAUST FAN, SHALL OPERATE AT MIN VENTILATION RATE OF 5 AIR CHANGES PER HOUR. RANGE HOOD O/ STOVE MAY COMPLY WHEN VENTED TO OUTSIDE & HAS MIN VENTILATION RATE OF 100CFM.

CALGREEN MANDATORY MEASURES

 DUCT SYSTEMS ARE SIZED, DESIGNED, & EQUIPMENT IS SELECTED PER SECT 4.507.2 HVAC SYS INSTALLER MUST BE TRAINED & CERTIFIED. SPECIAL INSPECTORS EMPLOYED

BY ENFORCING AGENCY MUST BE QUALIFIED. 2. AUTOMATIC IRRIGATION SYSTEM CONTROLLERS INSTALLED AT TIME OF FINAL INSPECTION SHALL

BE WEATHER-BASED, PER SECT 4.304.1 3. PROTECT ANNULAR SPACES AROUND PIPES, ELECTRIC CABLES, CONDUITS AT EXTERIOR WALLS AGAINST THE PASSAGE OF RODENTS, PER SECT 4.406.1

4. COVER DUCT OPENINGS & OTHER RELATED AIR DISTRIBUTION COMPONENT OPENINGS DURING CONSTRUCTION, PER SECT 4.504.1

5. ADHESIVES, SEALANTS, & CAULKS SHALL BE COMPLIANT WITH V.O.C. & OTHER TOXIC COMPOUND LIMITS, PER SECT 4.504.2.1

6. PAINTS, STAINS, & OTHER COATINGS SHALL BE COMPLIANT W/ V.O.C. LIMITS, PER SECT 4.504.2.2

7. AEROSOL PAINTS & COATINGS SHALL BE COMPLIANT W/ PRODUCT WEIGHTED M.I.R. LIMITS FOR R.O.C. & OTHER TOXIC COMPOUNDS PER SECT 4.504.2.3. VERIFICATION OF COMPLIANCE SHALL BE PROVIDED.

14. AT TIME OF FINAL INSPECTION A WRITTEN MANUEL SHALL BE PLACED IN THE RESIDENCE, OUTLINING OPERATING

9. MIN 50% OF FLOOR AREA RECEIVING RESILIENT FLOORING SHALL COMPLY W/ SECT 4.504.4 10. PARTICLEBOARD, MDF, & HARDWOOD PLYWOOD USED IN INTERIOR FINISH SYSTEMS SHALL COMPLY W/ LOW

8. CARPET & CARPET SYSTEMS SHALL BE COMPLIANT W/ V.O.C. LIMITS, PER SECT 4.504.3

FORMALDEHYDE EMISSION STDS, PER SECT 4.504.5 11. INSTALL CAPILLARY BREAK & VAPOR RETARDER AT SLAB ON GRADE FDNS, PER SECT 4.505.2 12. CHECK MOISTURE CONTENT OF BLDG MATERIALS USED IN WALL & FLOOR FRAMING BEFORE ENCLOSURE

PER SECT 4.505.3 13. PROVIDE INSULATED LOUVERS/COVERS (MIN R-4.2) WHICH CLOSE WHEN THE FAN IS OFF FOR THE WHOLE HOUSE EXHAUST FANS, PER SECT 4.507.1

INSTRUCTIONS AND MAINTENANCE INFORMATION PER CGBC SECTION 4.4101.1 - OPERATION AND MAINTENANCE MANUAL CRITERIA.


 $Z \subseteq$ Z

0 \bigcirc \mathbb{Z}_{0} 0 1 0 \Box 2 C \triangleleft 000 9 \bigcirc

 \triangleleft

 \triangleleft

 \sum

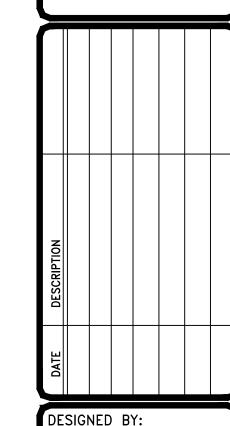

DRAWN BY: RT 3-17-22 PROJECT NO: 929

HEET NO:

3/23/2022 2:03:49 PM