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PROJECT DIRECTORY

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OWNER

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LANDSCAPE DESIGN

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BUILDING INFORMATION

1.ALL CONSTRUCTION SHALL CONFORM TO THE FOLLOWING CODES; -2019 CALIFORNIA RESIDENTIAL CODE, (CRC) BASED ON THE 2018 IRC W/ CAADM.) INCREASED, VERIFY WITH TITLE 24 REQ & CONTRACTOR. SPRINKLERED, OR VENT IS 12 FEET ABOVE A WALKING SURFACE OR GRADE BELOW PER CRC

FOR RESIDENTIAL PROJECTS -2019 CALIFORNIA FIRE CODE. (CFC) BASED ON THE 2018 IFC -2019 CALIFORNIA MECHANICAL CODE, (CMC) BASED ON THE 2018 UMC. -2019 CALIFORNIA PLUMBING CODE, (CPC) BASED ON THE 2018 UPC (W/ CA ADM.) -2019 CALIFORNIA ELECTRICAL CODE, (CEC) BASED ON THE 2017 NEC -2019 CALIFORNIA ENERGY CODE TITLE-24 PART 6 -2019 CALIFORNIA GREEN BUILDING STANDARD CODE (CAL GREEN) -ANY OTHER APPLICABLE STATE, COUNTY OR LOCAL REGULATIONS. 2.AMENDED CONSTRUCTION DOCUMENTS: WORK SHALL BE INSTALLED IN ACCORDANCE WITH THE APPROVED CONSTRUCTION DOCUMENTS, AND ANY CHANGES MADE DURING CONSTRUCTION THAT ARE NOT IN COMPLIANCE WITH THE APPROVED CONSTRUCTION DOCUMENTS SHALL BE RESUBMITTED FOR APPROVAL AS AN AMENDED SET OF CONSTRUCTION DOCUMENTS. 3.THE CONTRACTOR IS RESPONSIBLE TO CHECK THE PLANS AND IS TO NOTIFY THE DESIGNER OF ANY ERRORS OR OMISSIONS PRIOR TO THE START OF CONSTRUCTION. **ABBREVIATIONS**

BDRM

CLG.

CSMT.

FOUND.

T.O.P.

T.O.C.

T.O.SLAB

T.O.S.F.

T.O.B.

TYP.

U.O.N.

1 POLE / 1 SHELF

ABOVE FINISHED FLOOR

5 SHELVES

BEDROOM

BOTTOM OF

CONCRETE

DOWNSPOUT

FOUNDATION

FRENCH DOOR

HEEL HEIGHT

FIXED WINDOW

FLOOR

HEADER

HEIGHT

LAUNDRY

LAVATORY LINEN

MINIMUM

OPTIONAL

ROOF BELOW

SINGLE HUNG

SLIDER WINDOW

TEMPERED GLASS

TEMPERED GLASS

TOP OF PLATE

TOP OF CURB

TOP OF SLAB

TOP OF BEAM

TYPICAL

VERTICAL

WINDOW

WEATHER PROOF

VERIFY IN FIELD

WOOD

TOP OF SUBFLOOR

UNLESS OTHERWISE NOTED

TOP OF GRADED PAD

TONGUE AND GROOVE

NOT IN CONTRACT

OPPOSITE HAND

PRESSURE TREATED LUMBER

SEE STRUCTURAL DRAWINGS

CASEMENT WINDOW

DOWNSPOUT BELOW

FACE OF FRAMING

BELOW

CEILING

4.WRITTEN DIMENSIONS HAVE PRECEDENCE OVER SCALED DIMENSIONS. DO NOT SCALE DRAWINGS!!

5.INSULATION: (SEE TITLE 24 CF-1R FORM PER EFFS SECTION 150.1) 6.THE ABOVE VALUES ARE A DEFAULT MINIMUM VALUES AND MAY BE

7.ALL EXPOSED INSULATION IS TO HAVE A FLAME SPREAD RATING OF

LESS THAN 25 AND A SMOKE DENSITY RATING OF LESS THAN 450 8.ATTIC VENTS AND UNDERFLOOR VENT OPENINGS MUST RESIST THE INTRUSION OF FLAME AND EMBERS OR SHALL BE A MINIMUM OF 1/16" AND MAXIMUM 1/8" CORROSION-RESISTANT, NONCOMBUSTIBLE WIRE MESH OR EQUIVALENT. COMBUSTIBLE VENTS ON TOP OF ROOFS MAY BE COVERED WITH THIS MATERIAL TO COMPLY. VENTILATION OPENINGS ON THE UNDERSIDE OF EAVES ARE NOT PERMITTED, UNLESS A SFM APPROVED VENT IS INSTALLED, OR EAVES ARE FIRE

9.EACH SLEEPING ROOM SHALL HAVE A WINDOW OR EXTERIOR DOOR FOR EMERGENCY ESCAPE, SILL HEIGHT / CLEAR OPENING SHALL NOT EXCEED 44 INCHES ABOVE FINISH FLOOR. THE WINDOW MUST HAVE A MINIMUM NET OPENABLE AREA OF 5.7 SQ. FT. WITH A MINIMUM WIDTH OF 20 INCHES AND A NET OPENABLE HEIGHT OF 24 INCHES.(CRC 310 & R612.2)

10.TEMPERED WINDOW GLAZING REQUIRED; (CRC 308.4) -WITHIN 18 IN. OF THE FLOOR (OR MULLION @24" TO 30" AFF) -WITHIN 24 IN. OF ANY DOOR ARE TO BE.

-GLAZING ADJACENT TO STAIRWAYS, LANDINGS OR RAMPS WITHIN 36" OF WALKING SURFACE OR WHEN LESS THAN 60" ABOVE WALKING SURFACE (CRC 308.4 #7) -ALL DOOR GLAZING TO BE TEMPERED. MANUFACTURER'S DESIGNATING THE TYPE OF GLASS AND THE SAFETY GLAZING STANDARD WITH WHICH IT COMPLIES, WHICH IS

11. ALL EXTERIOR WINDOWS ARE TO BE DUAL GLAZED AND EXTERIOR DOORS ARE TO BE SOLID CORE WITH WEATHERSTRIPPING. PROVIDE

1/2 IN DEAD BOLT LOCKS ON ALL EXTERIOR DOORS AND LOCKING DEVICES ON ALL DOORS AND WINDOWS WITHIN 10 FT. (VERTICAL) OF GRADE.

VISIBLE IN THE FINAL INSTALLATION. (CRC R308.4 #1)

12.CARBON MONOXIDE-SMOKE ALARMS:(PER 2019 CRC 315.1) A)THE SMOKE ALARMS SHALL BE INSTALLED ALONG THE FOLLOWING LOCATIONS PER 2019 CRC 314.3: 1.IN EACH SLEEPING ROOM

2.OUTSIDE EACH SEPARATE SLEEPING AREA IN THE IMMEDIATE VICINITY OF THE BEDROOMS. 3.ON EACH ADDITIONAL STORY OF THE DWELLING.

THEY WILL ALL SOUND. (R314.4, R314.5, R315.1, R315.1.2 & R315.1.3)

PROVISIONS OF THIS CODE AND THE FIRE HOUSEHOLD WARNING EQUIPMENT PROVISIONS OF NFPA 72. SYSTEMS AND COMPONENTS SHALL BE CALIF. STATE FIRE MARSHAL LISTED AND APPROVED IN ACCORDANCE WITH

B)ALL SMOKE ALARMS SHALL BE LISTED IN ACCORDANCE WITH UL 217 AND INSTALLED WITH THE

CALIFORNIA CODE OF REGULATIONS, TITLE 19, DIV 1 FOR WHICH THEY WERE INSTALLED. C)ALL SMOKE ALARMS SHALL BE HARDWIRED WITH BATTERY BACK-UPAND INTER-CONNECTED, SO THAT, WHEN ANY ONE IS TRIPPED,

13.PROVIDE COMBUSTION AIR VENTS (W/SCREEN AND BACKDRAFT

14.INTERIOR VENTING REQUIREMENTS: (PER CES 1501 & CAL-GREEN)

-KITCHEN TO HAVE A MIN. OF 100 CFM EXAUST FAN -BATHROOM, LAUNDRY & WET ROOMS TO HAVE A MIN OF 50 CFRM EXAUST FAN

-WHOLE HOUSE VENTILATION (PER ANSI-ASHRAE 62.2) VENT RATE (CFM) = (CFA/100) + [7.5 X (NUMBER OF BEDROOMS +1)] VENTING TO BE PROVIDED BY EITHER EXAUST VENT, SUPPLY VENT OR A COMBINATION OF THE TWO. SEE SECTION 4.6 OF THE RESIDENCE COMPLIANCE MANUAL.

15.ELECTRICAL RECEPTACLES IN BATHROOMS, KITCHENS AND GARAGES SHALL BE G.F.I. OR G.F.I.C. (CEC 210.8)

16.EGREES STAIRWAY CONSTRUCTION TO MEET 2019 CRC STANDARD (SEC R311.7) -MAX 7.75" RISE AND MIN 10" RUN -MIN STAIRWAY HEADROOM 6'-8"

-MIN STAIRWAY WIDTH OF 36" -MIN TREAD WIDTH AT WINDERS IS 6" (MEASURE 12" FROM INSIDE OF CURVE) SEE R311.7.5.2.1 FOR "CURVED STAIRWAY" REQ

17.IN ALL ONE AND TWO FAMILY DWELLINGS, AN AUTOMATIC RESIDENTIAL FIRE SPRINKLER SYSTEM SHALL BE DESIGNED AND INSTALLED IN ACCORDANCE WITH SECTION R313 OR NFPA 13D.

18. GAS LINE SIZING DIAGRAM AND PIPE SPECIFICATION WILL BE SUBMITTED THE BUILDING DEPARTMENT PRIOR TO ROUGH PLUMBING INSPECTION.

PROJECT DESCRIPTION & SCOPE OF WORK

SCOPE OF WORK:

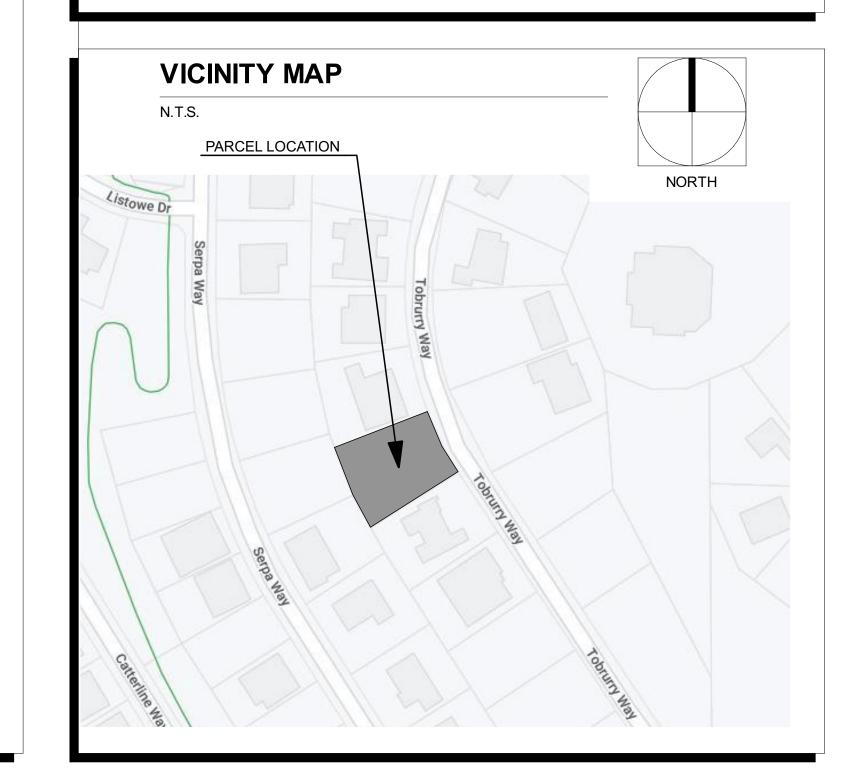
CONSTRUCT NEW SFD WITH 5 BEDROOMS AND 3-CAR GARAGE.

APN	072-2740-018-0000
ZONING	R-1-M (SP 95-1)
OCCUPANCY GROUP	R3/U
CONSTRUCTION TYPE	VB
NO. OF FLOORS	2,5
BUILDING HEIGHT	31' - 8"
LOT AREA	≈ 19,746 SQ FT / 0,4533 ACRES
LOT COVERAGE	7,695 SQ FT (38,97%)
FIRE SPRINKLERS	YES
WUI	NO

SQUARE FOOTAGE BREAKDOWN

		TOTAL (SQ.FT
MAIN LEVEL LIVABLE AREA		5,383
LOWER LEVEL LIVABLE AREA		3,269
GROUND LEVEL LIVABLE AREA		2,666
	TOTAL LIVABLE SPACE	11,318
3-CAR GARAGE		1, 043
COURTYARD		106
COVERED BALCONY		169
COVERED DECK #1		584
COVERED DECK#2		1,204
COVERED MASTER PATIO		174
PATIO		2,300
UNCONDITIONED STORAGE		579
STORAGE #1		27
STORAGE #2		32

DEFERRED SUBMITTALS:





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KRISHNA RESIDENCE

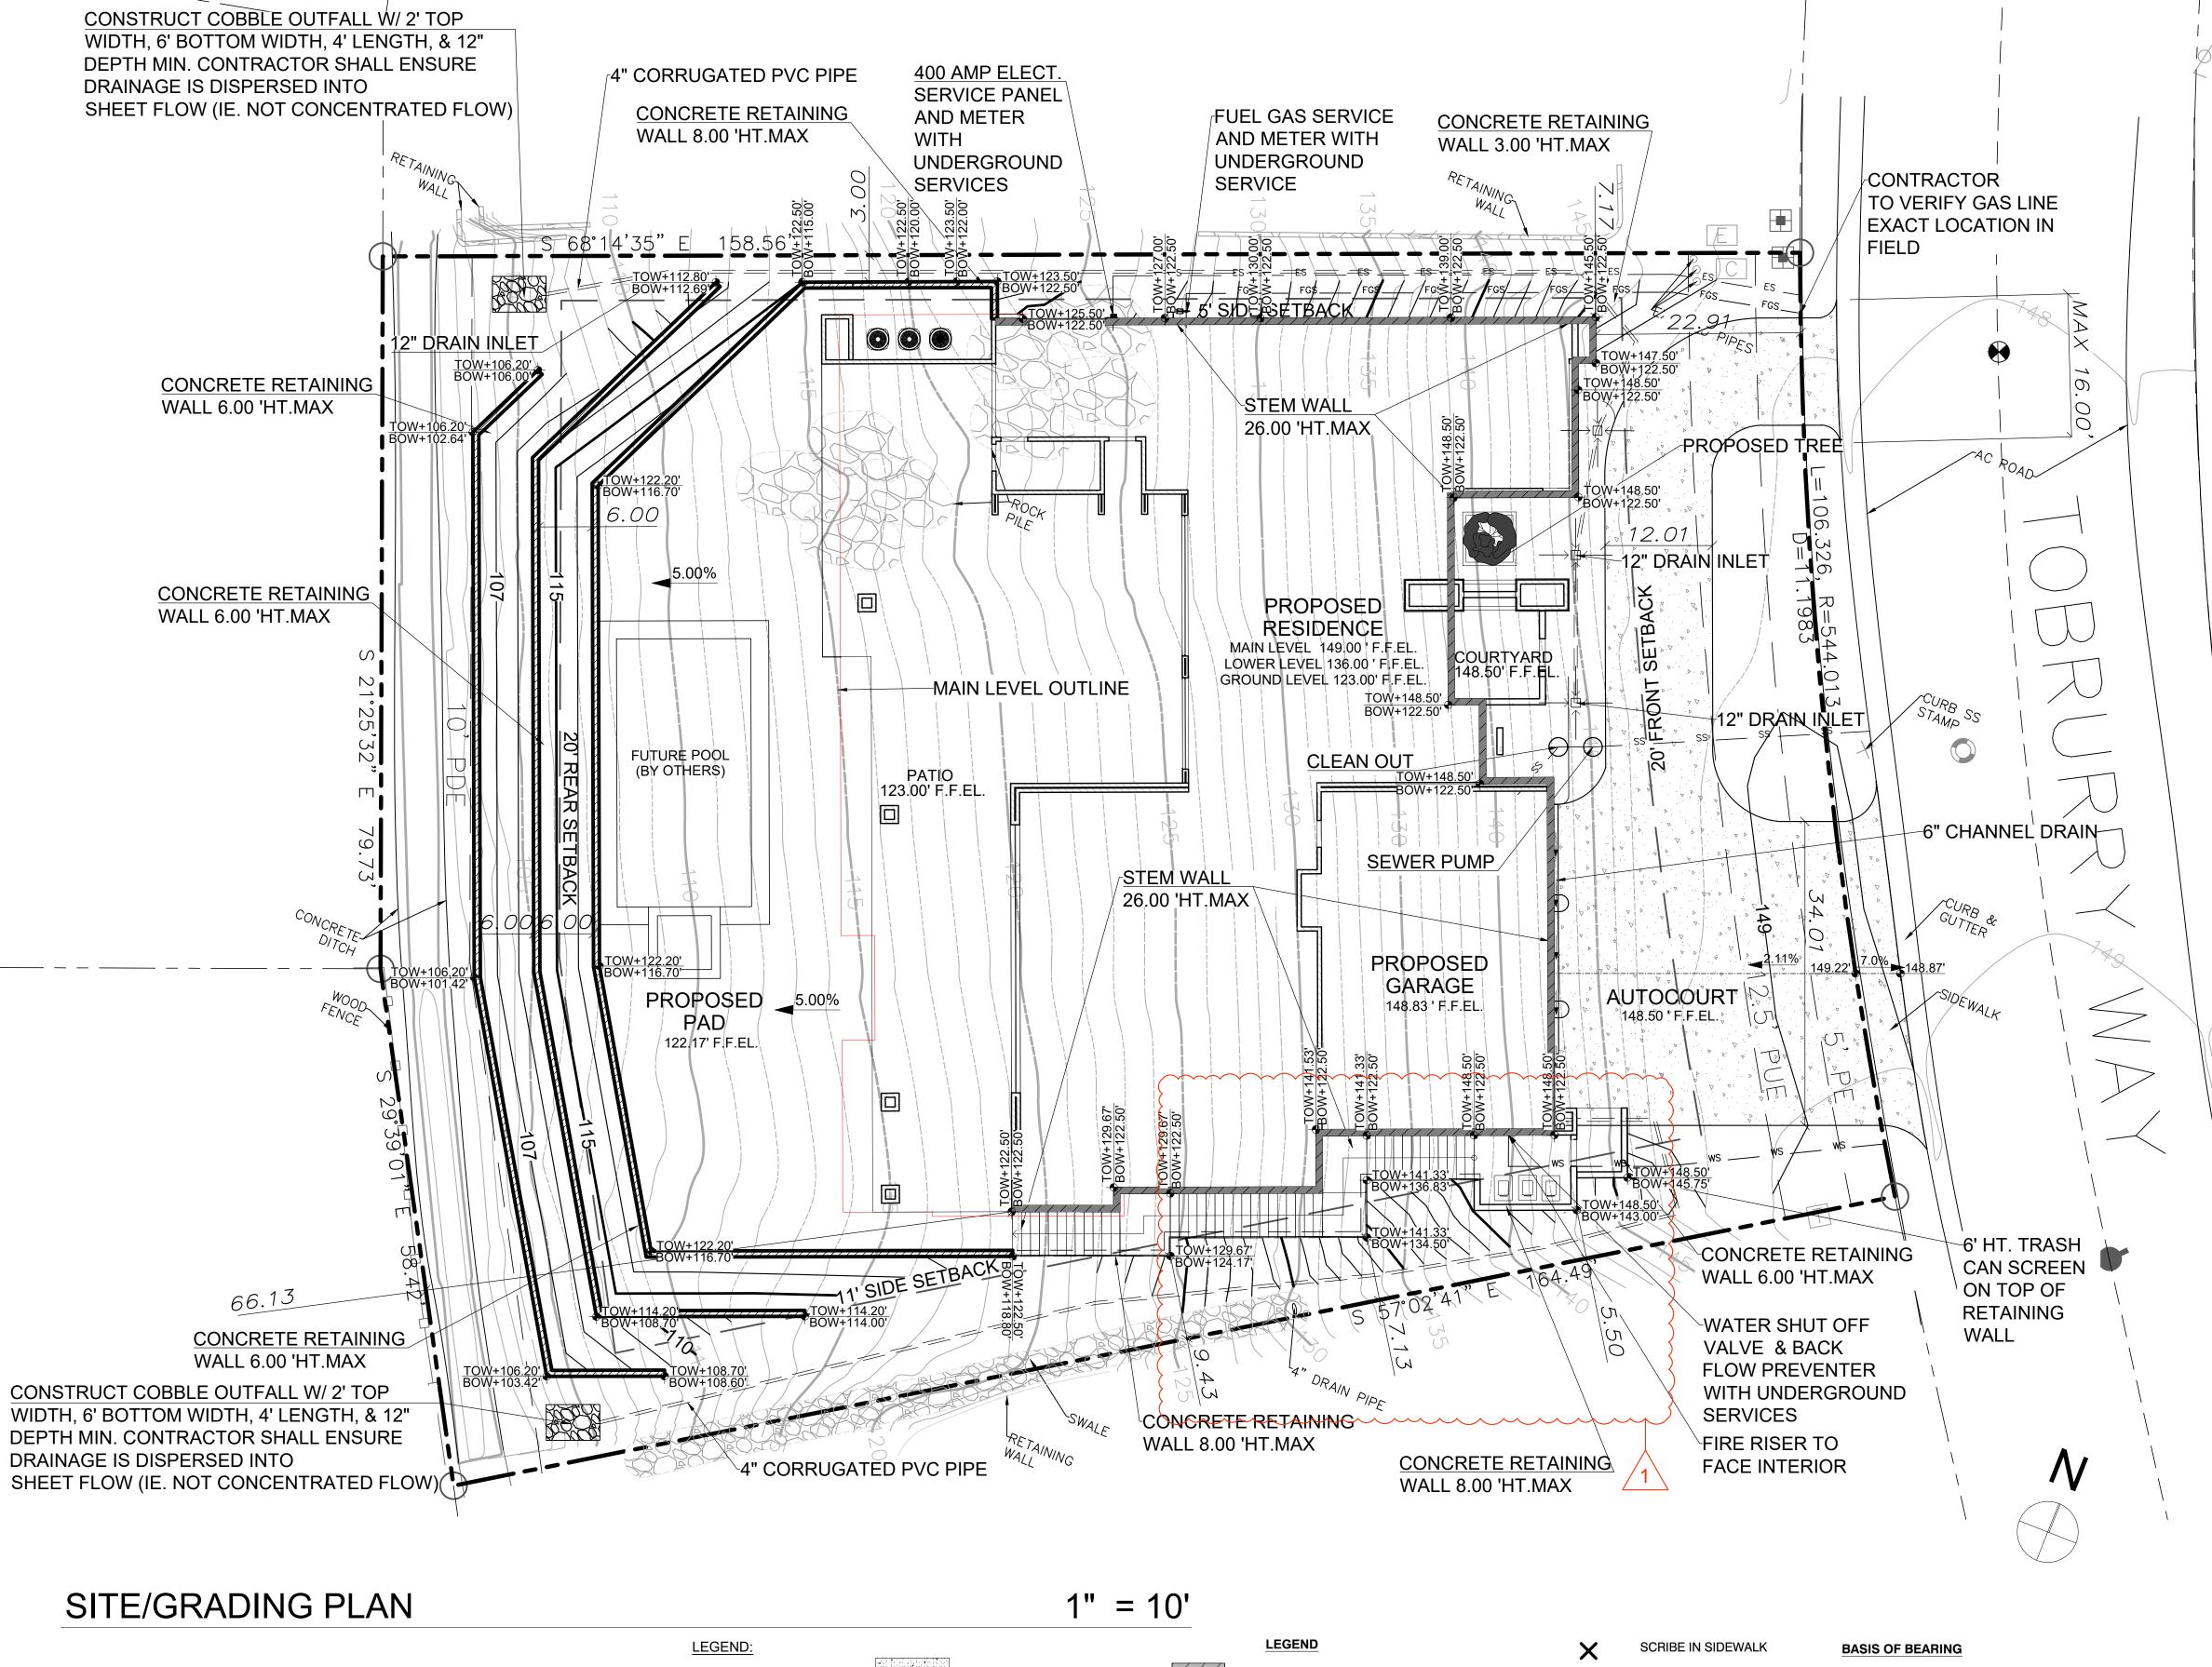
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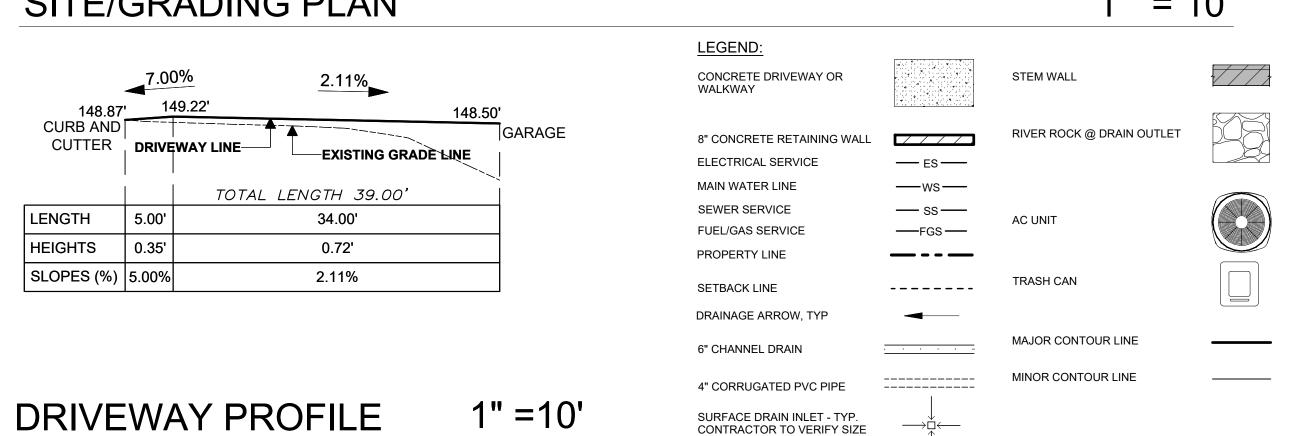
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REVISIONS MARK DATE DESCRIPTION

DRAWN BY: TANYA B. CHK'D BY: DEAN Z. COPYRIGHT: LEV DESIGNS

COVER PAGE





AND LOCATION

BOAC BACK OF AC DIKE CTRL **CENTER LINE FINISH GRADE** GCEE **GOLF COURSE GRADE BRAKE HIGH POINT** MULTI-PURPOSE EASEMENT OG ORIGINAL GRADE PUE PUBLIC UTILITY EASEMENT

ELEVATION BENCHMARK

FOUND MONUMENT

POSTAL EASEMENT PRIVATE DRAINAGE EASEMENT DIMENSION POINT

WATER METER SEWER MANHOLE

ELECTRIC VAULT TRANSFORMER

COMMUNICATIONS VAULT

Know what's **below. Call** before you dig.

THE BASIS OF BEARING OF THIS SURVEY IS ALIGNED

WITH THE SUBDIVISION MAP TITLED BROADSTONE UNIT

RECORDER, AND WAS ESTABLISHED USING DISCOVERED

NO. 3, VILLAGE 2-B, FILED OCTOBER 2005, IN BOOK 344

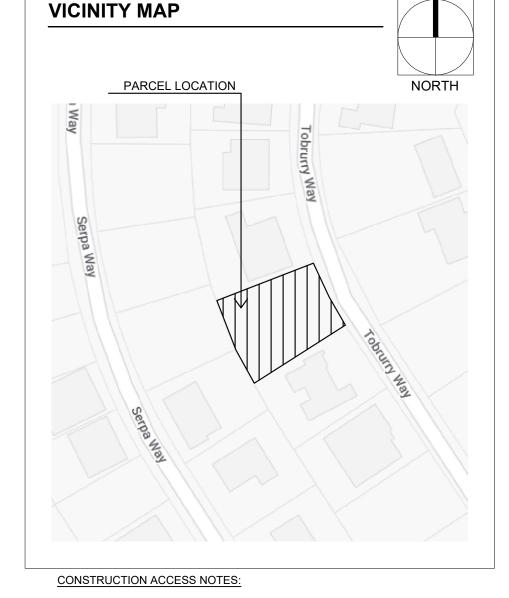
ELEVATION OF 148.15 AT MAG NAIL, SET IN ASPHALT

OF MAPS, PAGE 7, IN THE OFFICE OF COUNTY

MONUMENTS OF THE SAID MAP AND PARCEL.

ROADWAY, AS DEPICTED ON THIS MAP.

BENCHMARK INFORMATION



1.STABILIZED CONSTRUCTION SITE ACCESS SHALL BE CONSTRUCTED OF 40MM (3-6") MAX. AGGREGATE BASE MATERIAL CONFORMING TO COUNTY STANDARDS. MATERIAL SHALL BE PLACED TO A MIN. THICKNESS OF 150 MM (12"). THE METHOD OF PLACING, SPREADING AND COMPACTING AGGREGATE BASE MATERIAL SHALL CONFORM TO SECTION 26 OF THE STATE

2.LENGTH OF ENTRANCE SHALL BE A MIN. OF 15 METERS (50'). WIDTH SHALL BE A MIN. OF 4.5 METERS (15') OR GREATER IF NECESSARY TO COVER ALL VEHICULAR INGRESS AND EGRESS. PROVIDE AMPLE 3.THE ELEVATIONS OF THE BOTTOM OF THE RETAINING AND STEM

WALLS (BOW) ARE INDICATED AT THE POINT OF CONTACT OF THE RETAINING OR STEM WALL WITH THE FINISHED GRADE SURFACE, AND THE DETAILS OF THE FOUNDATION OF THE RETAINING AND STEM WALLS BELO W THE FINISHED GRADE SURFACE SHOULD BE CONSIDERED TOGETHER WITH THE STRUCTURAL DESIGN DRAWINGS AND DETAILS PROVIDED BY E.O.R. AND VERIFIED BY THE CONTRACTOR IN THE FIELD. 4.THE DRIVEWAY IS REQUIRED TO SUPPORT 75,000 LBS MIN.

SITE ADDRESS:

PROVIDE SITE ADDRESS (HOUSE NUMBER) PER 2019 CRC R319.1

DRAINAGE NOTES:

1. ALL ANCILLARY DRAIN PIPES (AREA DRAINS, LANDSCAPE DRAINS, TRENCH DRAINS, RETAINING WALL DRAIN LINES, ETC.) TO TIE INTO A STORM DRAIN PIPE OR DAYLIGHT INTO SWALE. 2. ALL DRAIN PIPE TO BE BURIED A MINIMUM 12" FROM FINISH GRADE 3. BELOW COBBLES, INSTALL FILTER FABRIC UNDERNEATH TO LIMIT FROSION. 4. GRADING SHALL BE ACCOMPLISHED TO DRAIN INTO 12" DRAIN INLETS.

GENERAL NOTES

1. THE CONTRACTOR SHALL VERIFY ALL DIMENSIONS, NOTES. DETAILS, AND OTHER RELATED ITEMS FOR THE PROJECT AND REPORT ANY ERROR, INCONSISTENCY AND/OR OMISSION TO THE DESIGNER PRIOR TO PROCEEDING WITH ANY WORK, IF CONFLICTS ARE FOUND, THE MOST STRINGENT CONDITIONS SHALL GOVERN. 2. DRAWINGS MAY NOT ALWAYS BE TO SCALE. NOTED DIMENSIONS SHALL TAKE PRECEDENCE. 3. ALL FRAMING MATERIAL TO BE D.F. #2 OR BETTER. THE CONTRACTOR SHALL COMPLY WITH THE LOCAL GOVERNING ADMINISTRATIVE AND TECHNICAL MANUAL FOR GRADING/EROSION CONTROL AND SEDIMENT CONTROL. PRIOR TO OCTOBER 1, CONTRACTOR SHALL HAVE ALL APPROPRIATE EROSION AND SEDIMENT CONTROL MEASURES IN PLACE FOR THE WINTER MONTHS.AND MUST ENSURE THAT THE CONSTRUCTION SITE IS PREPARED PRIOR TO THE ONSET OF ANY STORM. 4. CONTRACOR TO VERIFY LOCATIONS OF ALL THE UTILITIES IN FIELD.

SITE PLAN GENERAL NOTES:

A. FIELD VERIFY ALL EXISTING SITE CONDITIONS PRIOR TO STARTING ANY B. PROPERTY LINE (LOT SIZE) LENGTHS SHOWN ARE PLUS-MINUS TO ACTUAL LENGTHS AND ARE BASED ON FIELD MEASUREMENTS. C. ANY NEW CONCRETE SIDEWALK DESIGN IS SHOWN AS AN OPTION. OWNER TO MODIFY OR ADJUST AS NECESSARY. D.THE GROUND IMMEDIATELY ADJACENT TO THE NEW FOUNDATION SHALL BE SLOPED AWAY FROM BUILDING AT A SLOPE OF NOT LESS THAN 6" (5 PERCENT SLOPE) IN THE FIRST 10 FEET MEASURED PERPENDICULAR TO THE FACE OF THE WALL. IMPERVIOUS SURFACES WITHIN 10 FEET OF BUILDING SHALL BE SLOPED

LOT COVERAGE

LOT SIZE - 0.4533 ACRES = 19,746 SQ. FT LOT COVERAGE - 7899 SQ. FT. (40.0%)

EARTHWORK CALCULATIONS

1. THE ESTIMATED EARTHWORK CALCULATIONS ARE TO FULFILL THE REQUIREMENTS FOR A GRADING PERMIT ONLY AND ARE NOT TO BE USED IN A BID DOCUMENT. IT IS THE CONTRACTORS RESPONSIBILITY TO VERIFY THESE CALCULATIONS. FOOTINGS. JTILITY TRENCHING, POOL & SPA NOT INCLUDED WITHIN

EARTHWORK QUABTITIES (OVERALL PROFECT SITE):

EMBANKMENT (FILL) EXCAVATION (CUT) SITE TOTAL (IMPORT)

SITE DISTURBANCE:

MUNICIPAL CODE

17039 SQ. FT. FOR ALL CONSTRUCTION ACTIVITY

HAUL ROUTE REQUIRED PRIOR TO CONSTRUCTION

FRONT YARD IMPERVIOUS AREA CALCULATIONS

40% MIN OF PERMEABLE SURFACE ALLOWED PER 10.20.470 FOLSOM

+ -1428 CY

+ -2008 CY

+ - 580 CY

FRONT YARD AREA: 2,165.64 SQ. FT. DRIVEWAY IM PERMEABLE AREA: 1,280.33 SQ. FT (59.12% OF FRONT YARD PERMEABLE SURFACE: 885.28 SQ. FT (40.88% OF FRONT YARD AREA)



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LANDSCAPE DESIGN

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REVISIONS

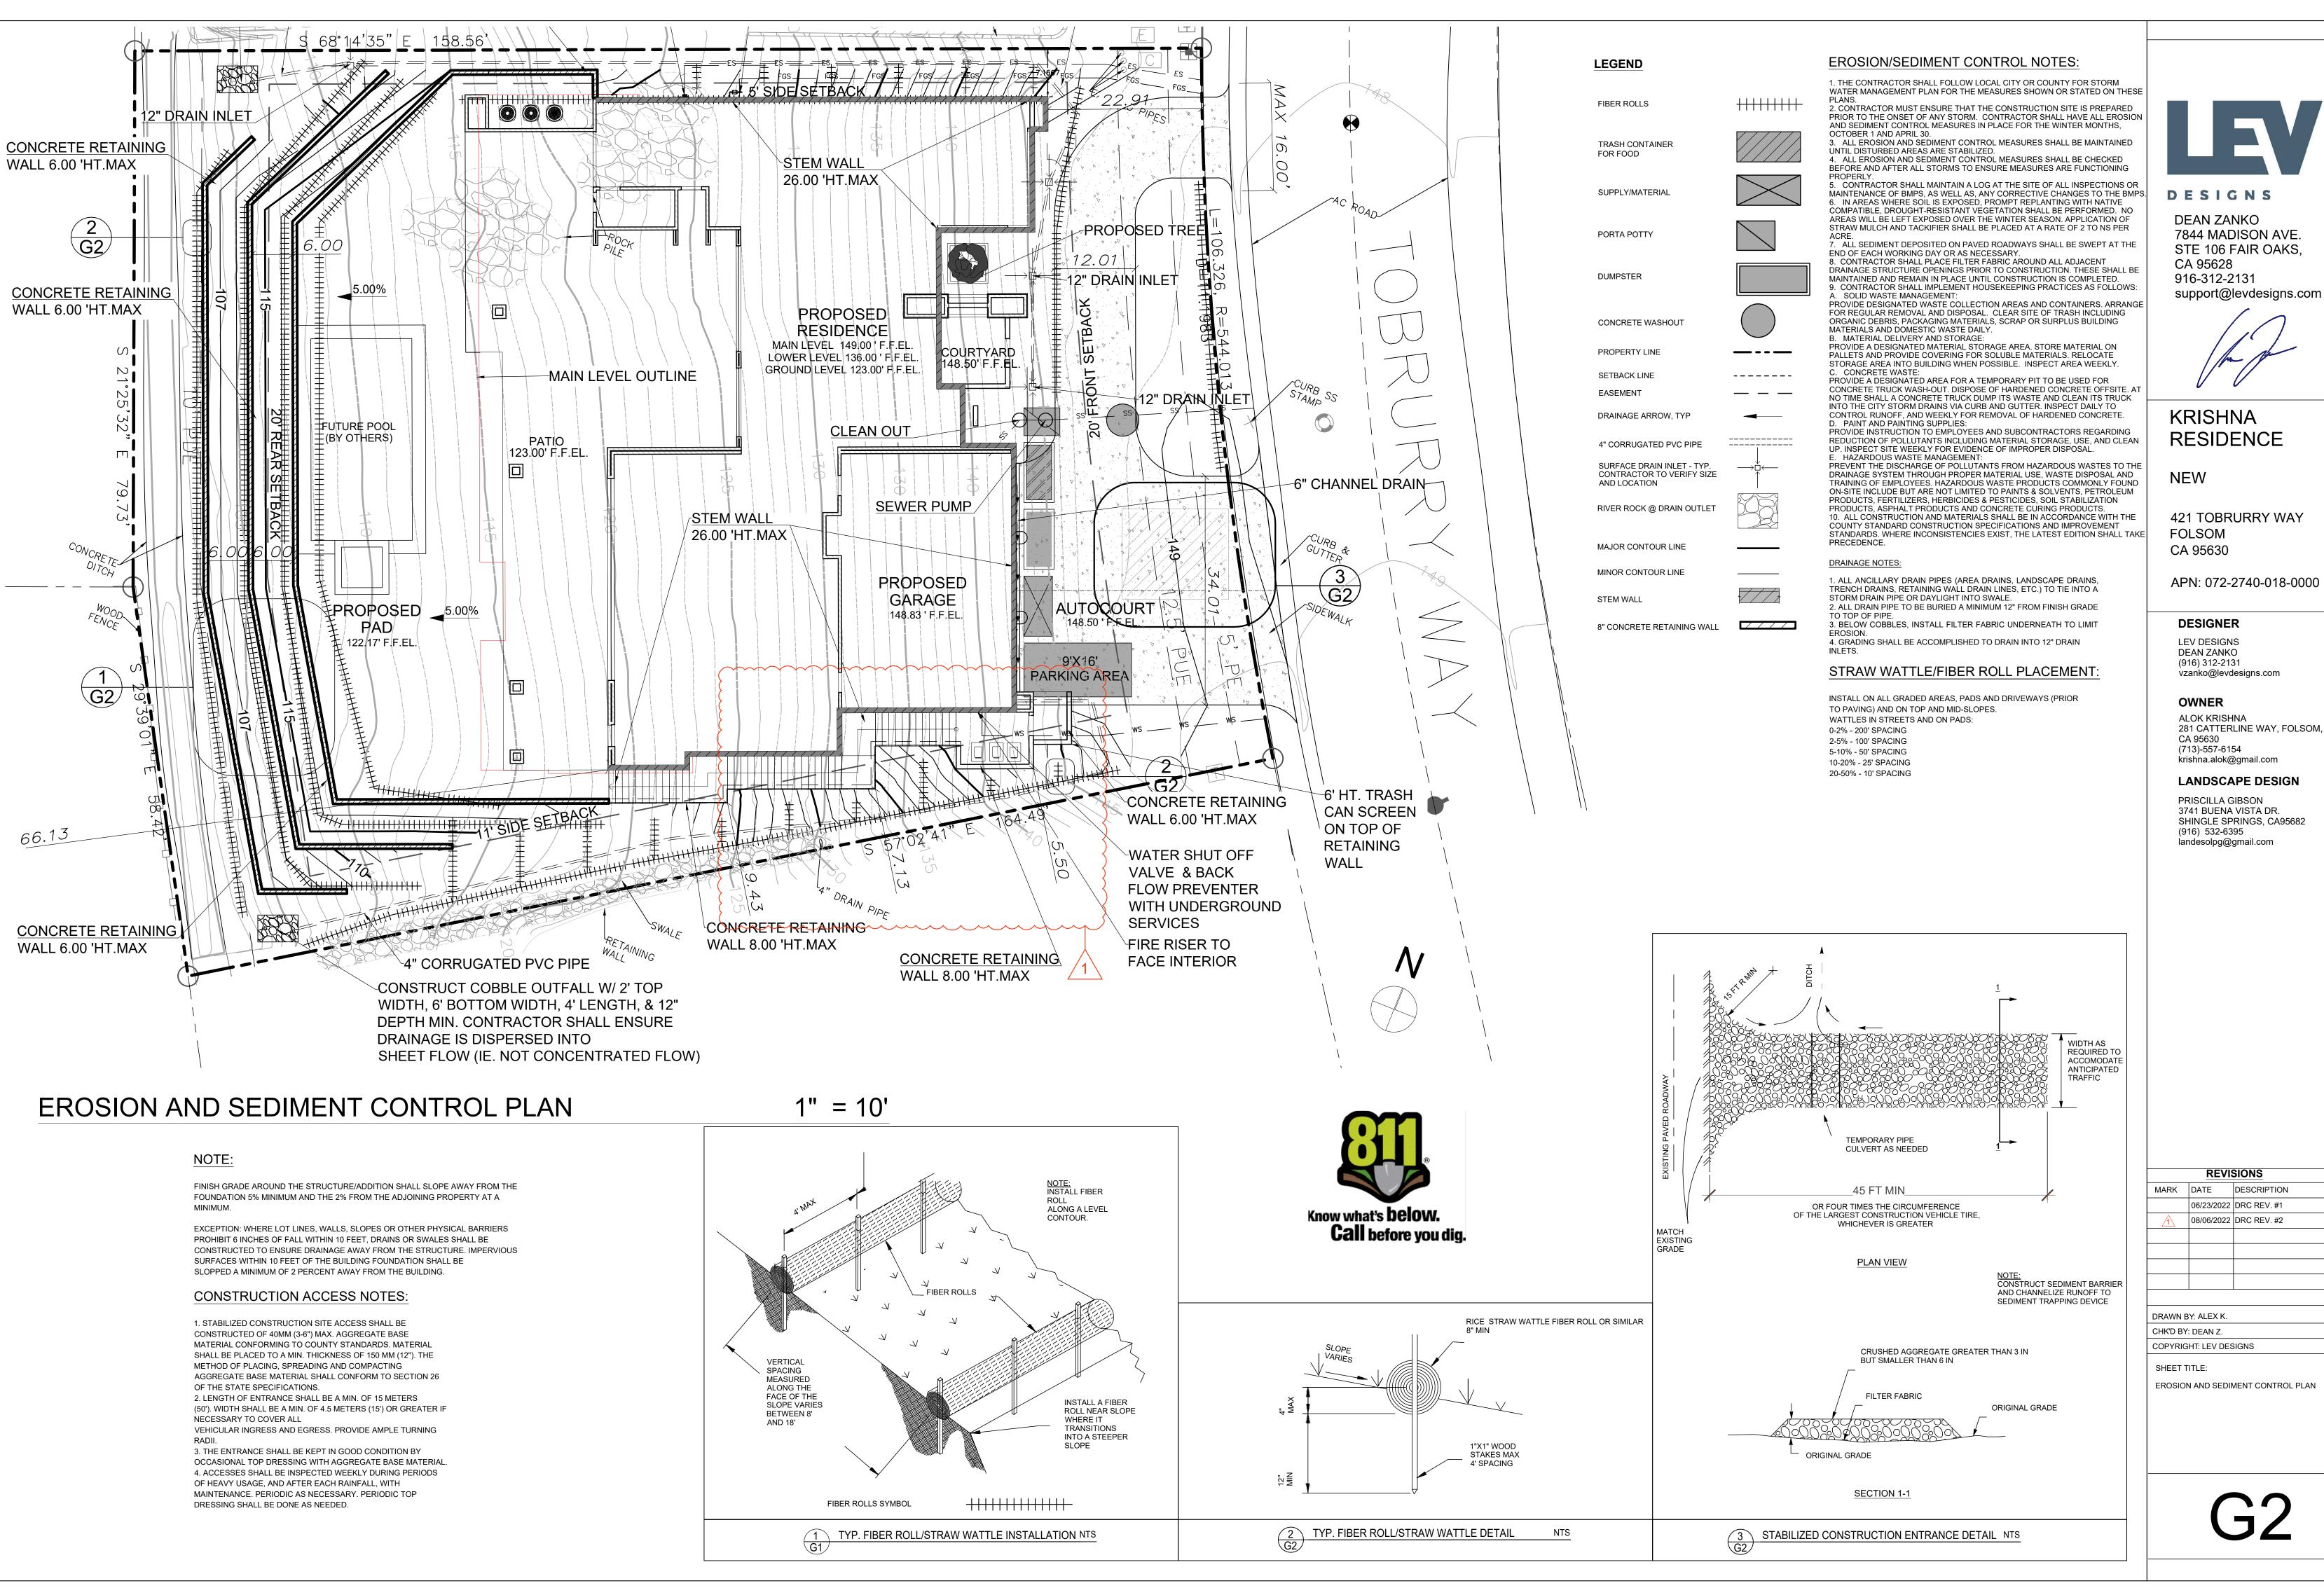
	MARK	DATE	DESCRIPTION
		06/23/2022	DRC REV. #1
	\triangle	08/06/2022	DRC REV. #2
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SHEET TITLE:

SITE/GRADING PLAN



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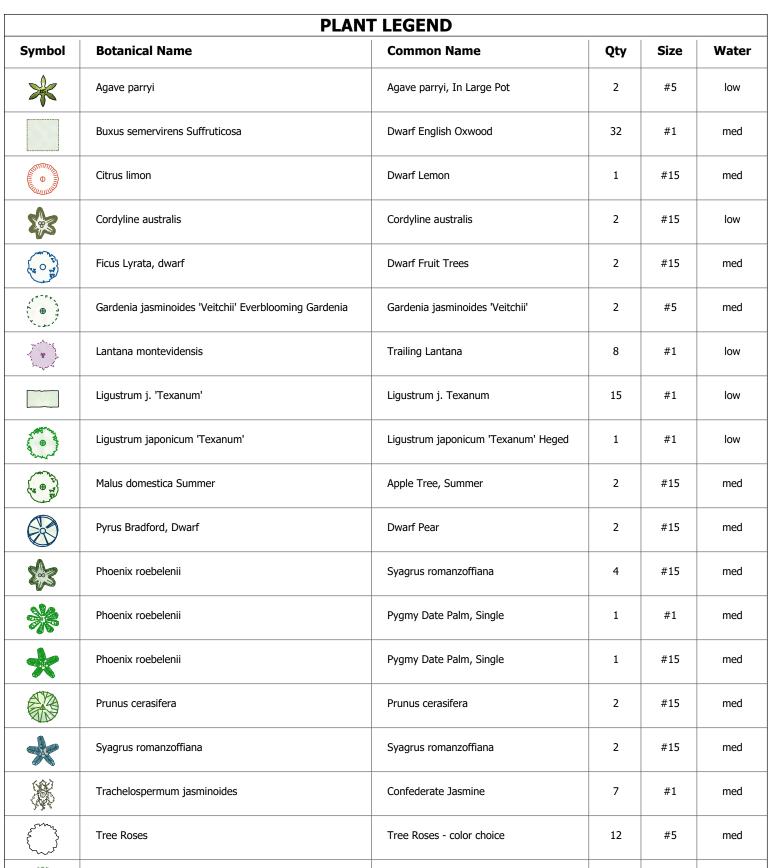
REVISIONS

06/23/2022 DRC REV. #1 08/06/2022 DRC REV. #2

EROSION AND SEDIMENT CONTROL PLAN

Buxus semervirens Suffruticosa

Prunus cerasifera



ALL PLANTS MAY NOT BE AVAILABLE AT PLANTING TIME. CONSULT WITH LANDSCAPE DESIGNER, LANDSCAPE CONTRACTOR OR NURSERY PROFESSIONAL FOR SUITABLE SUBSTITIONS COMPLIANT TO WUCOLS LOW OR MED WATER REQUIREMENTS

(1.) PLANS ARE DIAGRAMMATIC. CONTRACTOR/OWNER SHALL BE RESPONSIBLE FOR FIELD VERIFYING ALL EXISTING CONDITIONS AND ADJUST PLAN ACCORDINGLY. (2.) ALL PLANT MATERIALS SHALL MEET SIZE SPECIFICATIONS AS SHOWN ON THE PLANT LIST/LEGEND, AND SHALL BE HEALTHY, FULL, AND SHALL BE OF FIRST RATE QUALITY FOR THE SPECIES. (3.) NO PLANTING SHALL BE STARTED UNTIL FINISH GRADING AND IRRIGATIONS SYSTEM

HAVE BEEN COMPLETED. (4.) THE LOCATIONS OF TREES AND SHRUBS SHALL BE ADJUSTED IN THE FIELD TO ACCOMODATE EXISTING UTILITIES, LIGHTS, SPRINKLERS, ETC. (5.) CONTRACTOR(S) SHALL CULTIVATE LAWN AND PLANTING AREAS WITH APPROVED

TOP DRESS TO A 3" MINIMUM DEPTH IN ALL NON-TURF, PLANTER BEDS. (7) PLANTER BED MULCH SHALL BE SMALL CHIPPED BROWN. MULCH SHALL BE FREE OF LARGE WOODY PIECES, SOIL, STONES, STICKS, DEBRIS OR OTHER FOREIGN MATTER. (8) SOIL AMENDMENTS SHALL BE APPLIED AT THE RATE OF 6 CUBIC YARDS PER 1000 SQUARE FEET AND THOROUGHLY CULTIVATED INTO THE SOIL PRIOR TO PLANTING. AMENDMENTS TO BE NITRIFIED WOOD COMPOST OR EQUAL FREE OF SEED AND NON-ORGANIC MATERIALS.

SOIL AMENDMENTS.

TO THE PREVAILING WIND PATTERN, WITH 8' LODGE-POLE STAKED OUTSIDE THE PLANTING PIT AND TIED WITH FLEXIBLE TIES. (10.) PLANTERS WHICH SOIL WAS EXCAVATED SHALL RECEIVE NEW TOPSOIL AMENDED AS IN NOTE #8.

(11.) PLANTING PITS SHALL BE 2 TIMES (2X) THE DIAMETER OF THE ROOT BALL AND 2" LESS THAN THE DEPTH OF THE ROOT BALL. (12.) CONTRACTOR/OWNER SHALL ABIDE BY ALL LOCAL, STATE AND FEDERAL LAWS,

CODES AND ORDINANCES. (13.) LANDSCAPE DESIGNER SHALL NOT BE HELD RESPONSIBLE FOR ANY REVISIONS OR DEVIATIONS TO THESE DRAWINGS.

(14.) ALL REVISIONS MUST BE INITIALED AND DATED BY THE LANDSCAPE DESIGNER. FAILURE TO DO SO RELEASES LANDSCAPE DESIGNER FROM LIABILITY.



12 #1

low



Society Garlic

Tulbaghia Violacea 'Silver Lace'

Marker GAS SERVICE



OVERVIEW OF BACK YARD



POOL EQUIPMENT & AC ENCLOSURE



06/16/2022

LANDSCAPE PLAN AREA & SCOPE

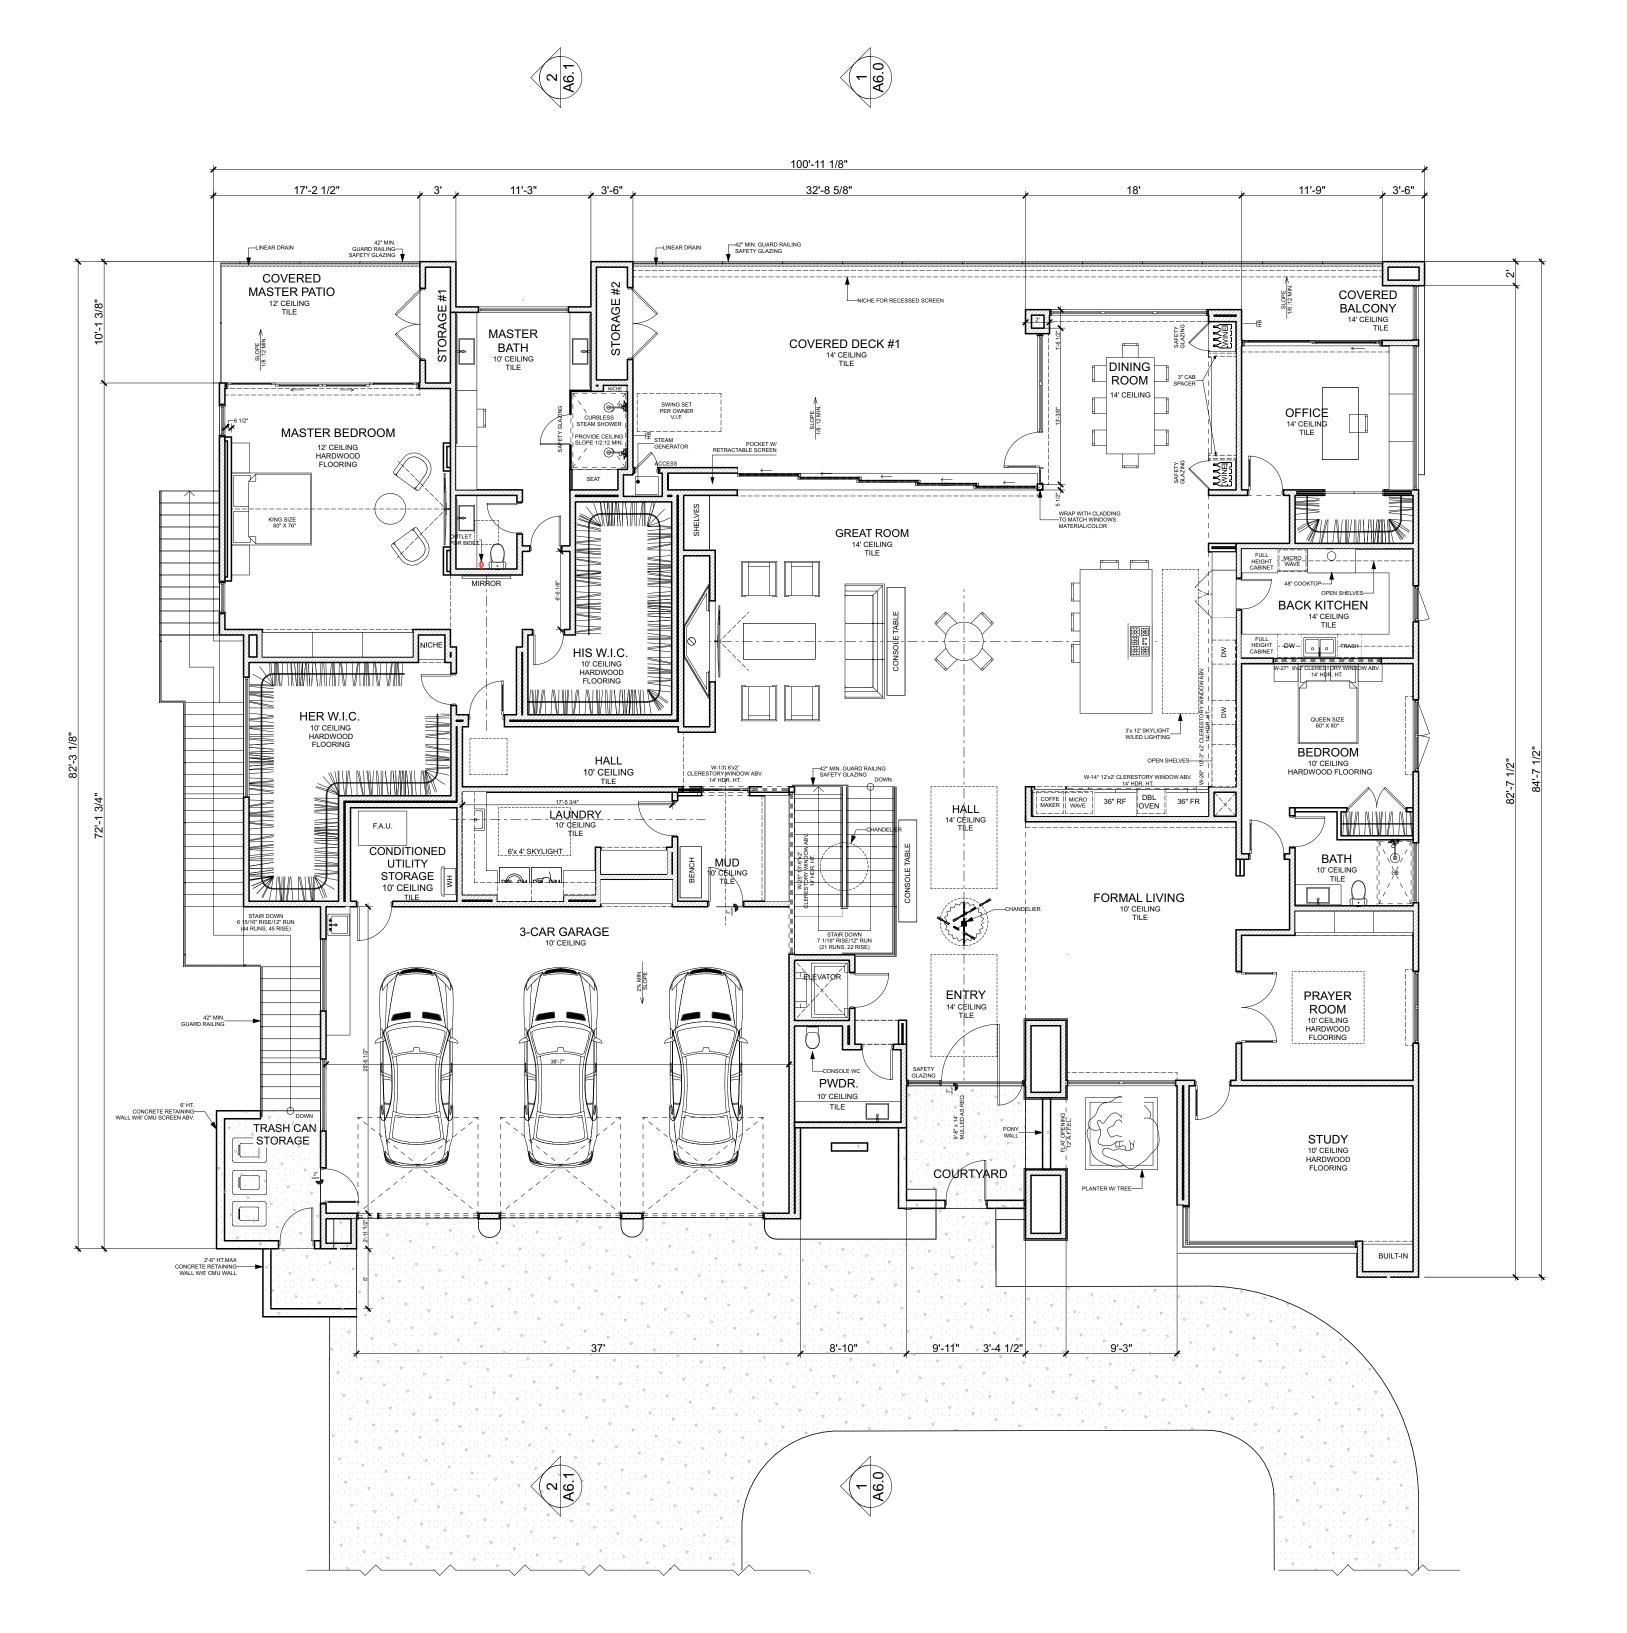
1 OF 1

PAGE

1/8" = 1' 0" SCALE



LANDSCAPE D E S | G N SOLUTIONS **PLANTING NOTES** (6.) AFTER PLANTING IS COMPLETE AND AREAS HAVE BEEN FINE GRADED, SPREAD BARK (9.) ALL FIVE-GALLON AND LARGER TREES SHOULD BE DOUBLE STAKED, PERPENDICULAR



1. ALL EXTERIOR DIMENSIONS TO FACE OF STUD, FACE OF FOUNDATION, & FACE OF STOREFRONT (U.O.N.)
2. ALL INTERIOR DIMENSIONS TO FACE OF STUD (U.O.N.)

3. ALL DIMENSIONS AT WINDOWS & DOORS ARE TO THE CENTERLINE. (U.O.N.)

4. ALL DOOR JAMBS ON HINGE SIDE SHALL BE 4" U.O.N.
5. ALL ANGLED WALLS (OTHER THAN 90 DEGREES) SHALL BE 45 DEGREES U.O.N.

6. ALL EXTERIOR WALLS SHALL BE CONSTRUCTED OF 2"X6" 16" O.C. STUDS, U.O.N., S.S.D. 7. ALL INTERIOR WALLS SHALL BE CONSTRUCTED OF 2'X4' 16" O.C. STUDS, U.O.N., S.S.D.

8. SUB-CONTRACTOR SHALL INSURE THAT ALL WORK IS DONE IN A PROFESSIONAL WORKMANLIKE MANNER BY SKILLED MECHANICS AND SHALL REPLACE ANY MATERIALS OR ITEMS DAMAGED BY SUB-CONTRACTORS PERFORMANCE. SUB-CONTRACTORS AND SUPPLIERS ARE HEREBY NOTIFIED THAT THEY ARE TO CONFER AND COOPERATE FULLY WITH EACH OTHER DURING THE COURSE OF CONSTRUCTION TO DETERMINE THE EXACT EXTENT AND OVERLAP OF EACH OTHER'S WORK AND TO SUCCESSFULLY COMPLETE THE EXECUTION OF THE

WORK. ALL SUB-CONTRACTOR WORKMANSHIP WILL BE OF QUALITY TO PASS INSPECTIONS BY LOCAL AUTHORITIES, LENDING INSTITUTIONS, ARCHITECT/DESIGNER, OR BUILDER. ANY ONE OR ALL OF THE ABOVE MENTIONED INSPECTORS MAY INSPECT WORKMANSHIP AT ANY TIME, AND ANY CORRECTIONS NEEDED TO ENHANCE THE QUALITY OF BUILDING WILL BE DONE IMMEDIATELY. EACH SUB-CONTRACTOR, UNLESS PECIFICALLY EXEMPTED BY THE TERMS OF HIS SUB-CONTRACT AGREEMENT, SHALL BE RESPONSIBLE FOR CLEANING UP AND REMOVING FROM THE JOB SITE ALL TRASH AND DEBRIS NOT LEFT

BY OTHER
SUB-CONTRACTORS. BUILDER WILL DETERMINE HOW SOON AFTER SUB-CONTRACTOR COMPLETES EACH
PHASE OF HIS WORK THAT TRASH AND DEBRIS WILL BE REMOVED FROM THE SITE.

9. ALL TEMPERED GLASS SHALL BE AFFIXED WITH A PERMANENT LABEL PER 2019

10. PROVIDE ACCOUSTICAL PIPE WRAP AT ALL SECOND FLOOR WASTE LINES.

11. TILE INSTALLATION SHALL COMPLY W/ APPLICABLE SECTIONS OF THE TILE COUNCIL OF NORTH AMERICA'S "HANDBOOK FOR CERAMIC TILE INSTALLATION" AND ITS REFERENCED STANDARDS.

12. ALL COUNTERS, TUB DECKS & WALLS AT TUBS & SHOWERS SHALL HAVE SMOOTH, HARD,

NONABSORBENT SURFACE O/ CEMENTITIOUS BACKER BOARD AND A MOISTURE RESISTANT UNDERLAYMENT TO

13. PROVIDE BACKING FOR ALL WALL AND CEILING MOUNTED CABINETS, FIXTURES, CABINETS, BRACKET, GRAB BARS, ETC. AS REQUIRED. COORDINATE WITH SUPPLIERS FOR REQUIREMENTS.

14. CALCULATIONS AND DETAILS FOR MOUNTING HANDRAILS & CONNECTION OF GUARDRAILS SHALL BE PROVIDED FOR REVIEW AND APPROVAL BY RAILING FABRICATOR PRIOR TO INSTALLATION FOR COMPLIANCE WITH 2019
15. VERIFY APPLIANCE DIMENSIONS PRIOR TO CABINET FABRICATION

16. 1 LAYER 1/2" GYP. BD. ON ALL WALLS OF GARAGE. CRC R308.1. A HEIGHT OF +72" ABOVE FLOOR PER 2019 CRC R307.2 CRC TABLE R301.5 2019 CRC TABLE R302.6 (2019 CRC R311.7.5.1).

17. A DRAFT STOPS TO BE PROVIDED IN THE FLOOR/CEILING ASSEMBLIES AND ATTIC (CBC SECTIONS 718.3.3 AND 718.4.3 AND R302.12). DRAFT STOPPING SHALL DIVIDE THE CONCEALED SPACE INTO APROXIMATELY EQUAL AREAS. CBC 718.4.3 DRAFTSTOPPING SHALL BE INSTALLED IN ATTICS AND CONCEALED ROOF SPACES, SUCH THAT ANY HORIZONTAL AREA DOES NOT EXCEED 3,000 SQ. FT. CONTRACTOR TO VERIFY IN FIELD.

18. EXTERIOR DOORS: RECESS CONCRETE (WHERE OCCURS) AT DOOR THRESHOLDS TO MINIMIZE THRESHOLD HEIGHT - COORDINATE WITH FLOORING (WOOD, CARPET, OR EXPOSED CONCRETE, ETC). CONSULT MANUFACTURER FOR ANY THRESHOLD REQUIEMENTS FOR CONCRETE SLAB APPLICATIONS. THRESHOLD MUST COMPLY WITH MANUFACTURER'S WEATHER-PROOFING REQUIREMENT 19. 2" RECESS. RECESS FOUNDATION AT ALL RECESSED DOORS.

WALL LEGEND:

2"X4" @16" O.C.

2"X6" @16" O.C.

8" CONCRETE WALL

DROPPED CEILING OR SOFFIT L _ _ _ J

CONCRETE LANDING

SQUARE FOOTAGE BREAKDOWN:

MAIN LEVEL FLOOR PLAN 5 382 SQ.FT.
LOWER LEVEL 3 269 SQ.FT.
GROUND LEVEL 2 666 SQ.FT.

11 317 SQ.FT.

3-CAR GARAGE 1 043 SQ.FT.

COURTYARD 106 SQ.FT.

COVERED BALCONY 170 SQ.FT.

COVERED DECK #1 584 SQ.FT.

COVERED DECK #2 1 204 SQ.FT.

COVERED MASTER PATIO 174 SQ.FT.

PATIO 2 300 SQ.FT.

STORAGE #1 27 SQ.FT.

STORAGE #2 32 SQ.FT.

UNCONDITIONED 579 SQ.FT.

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DESIGNS

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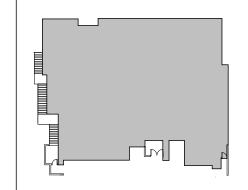
KRISHNA RESIDENCE

NEW

421 TOBRURRY WAY FOLSOM CA 95630

072-2740-018-0000

KEY PLAN:



REVISIONS

MARK DATE DESCRIPTION

08/07/2022

PROJECT NO:

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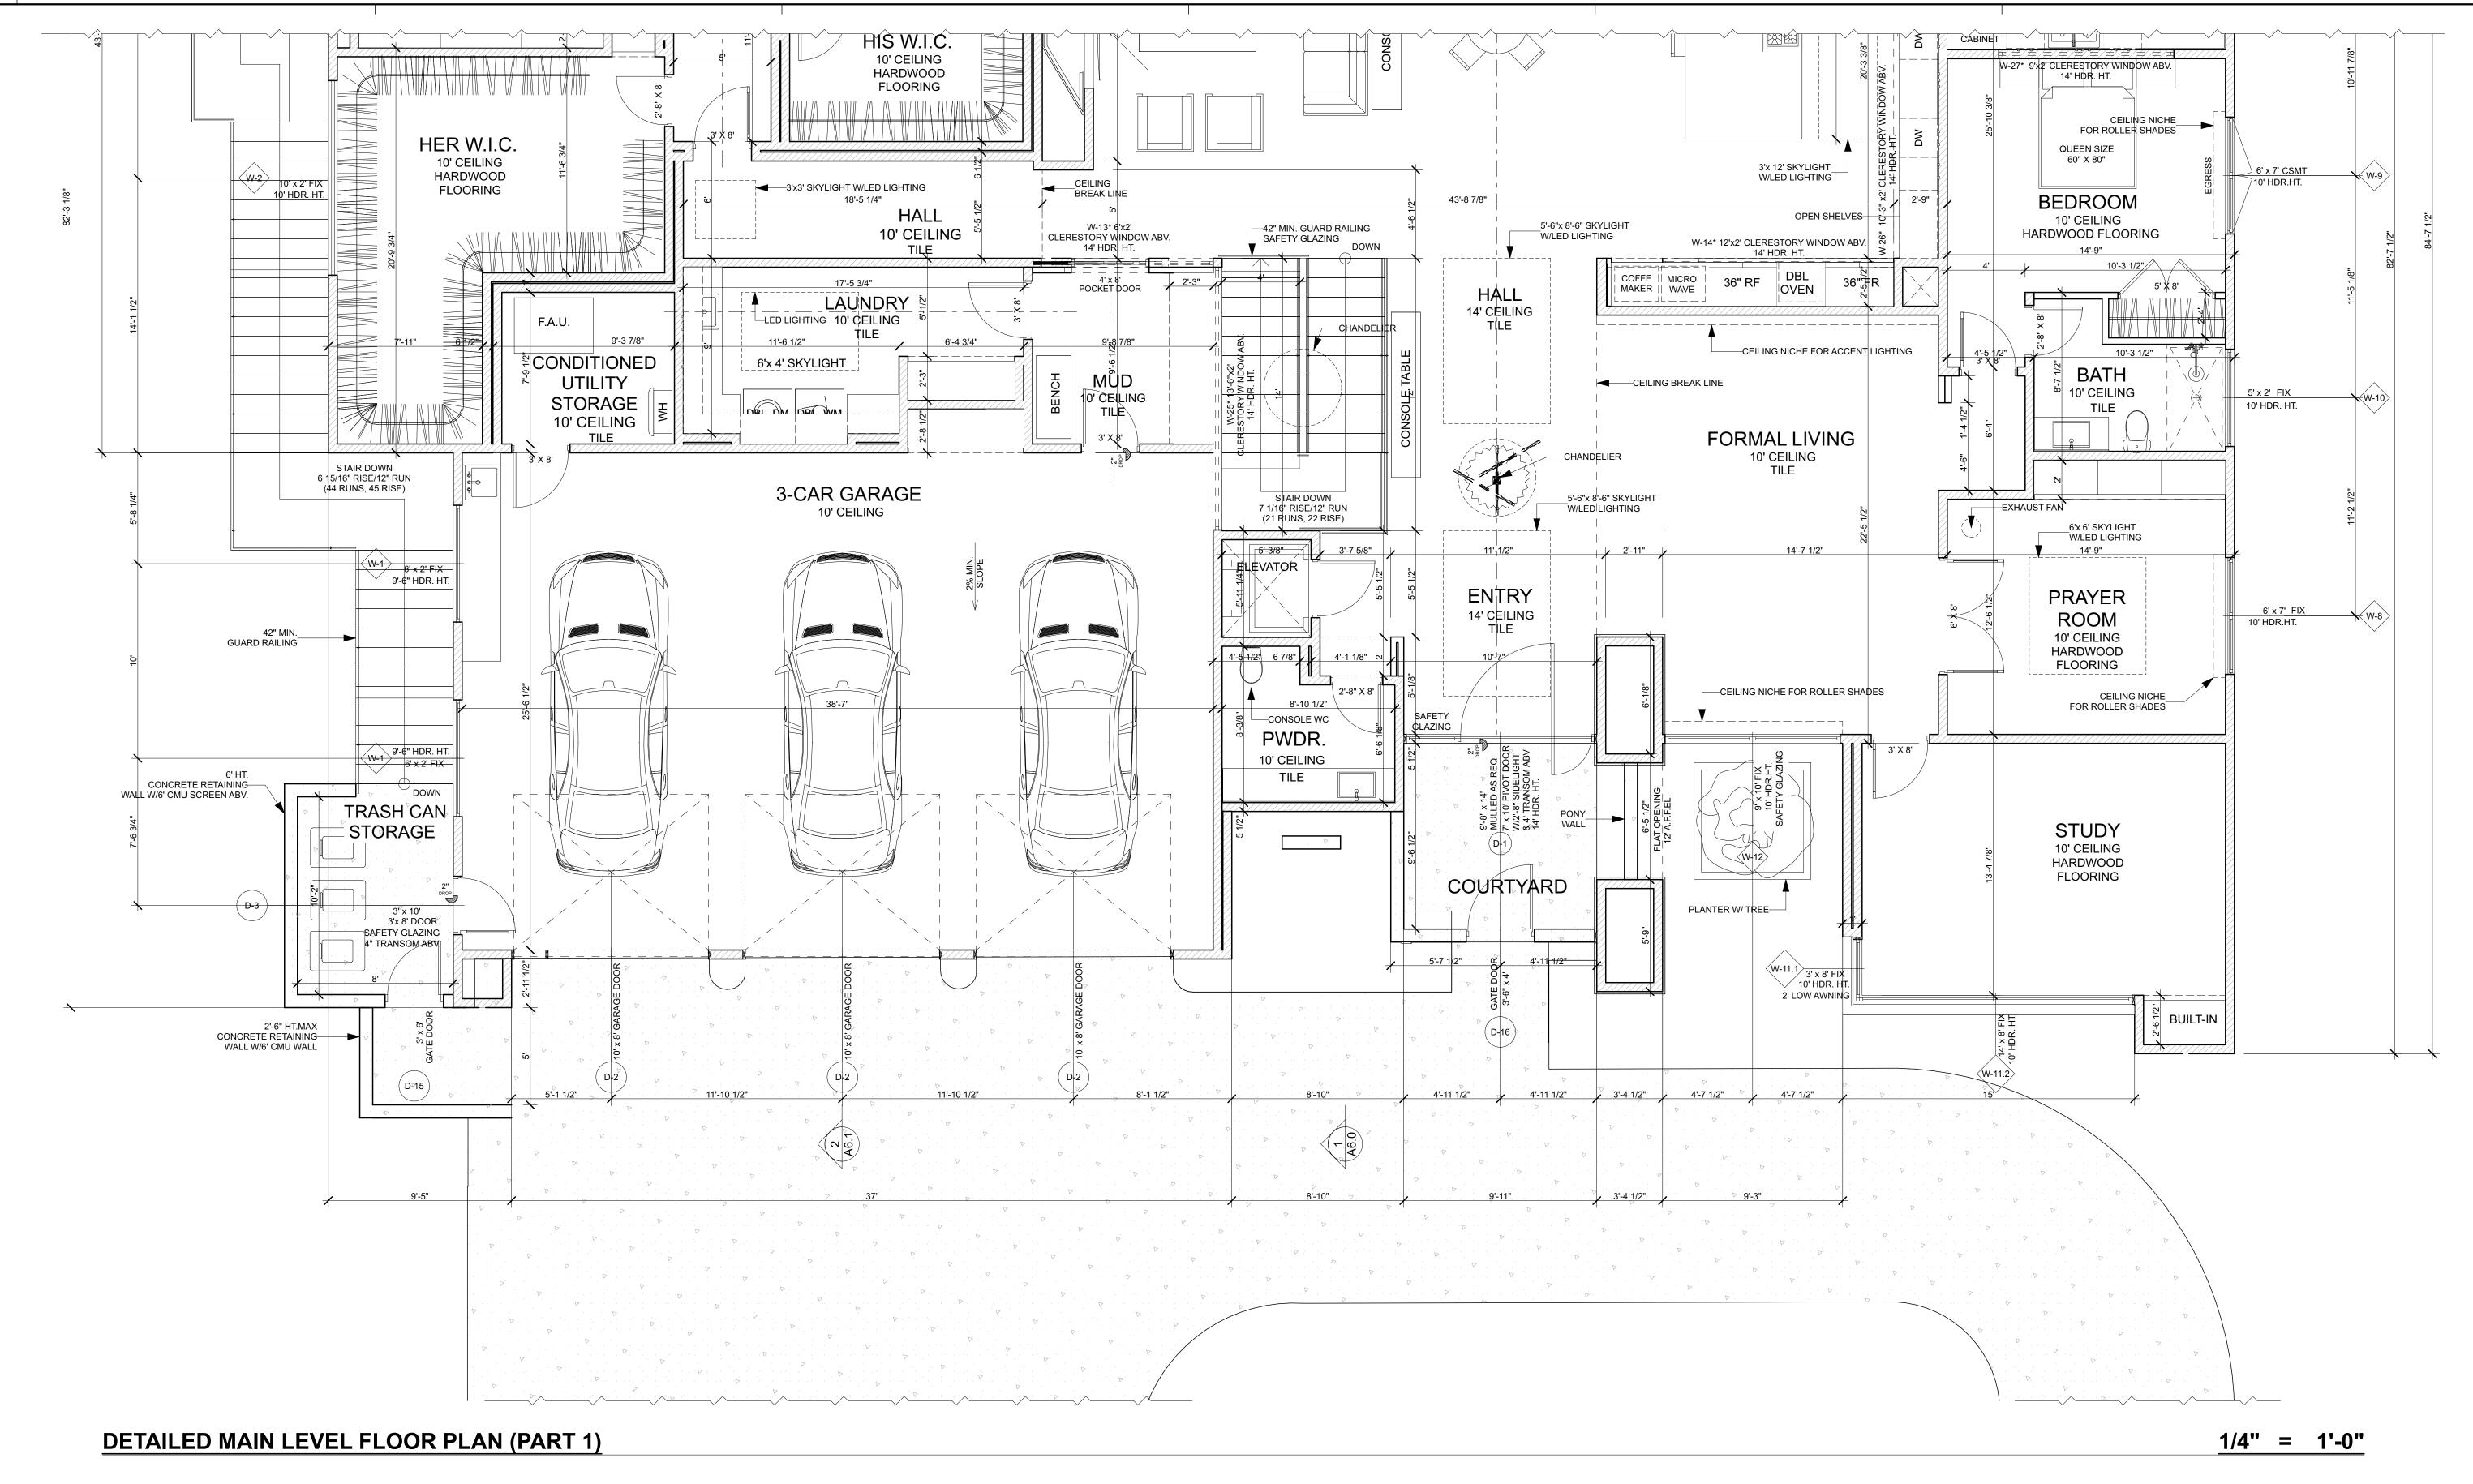
OVERALL MAIN LEVEL

FLOOR PLAN

OVERALL MAIN LEVEL FLOOR PLAN

1/8" = 1'-0"

A3.0



1. ALL EXTERIOR DIMENSIONS TO FACE OF STUD, FACE OF FOUNDATION, & FACE OF STOREFRONT (U.O.N.) 2. ALL INTERIOR DIMENSIONS TO FACE OF STUD (U.O.N.) 3. ALL DIMENSIONS AT WINDOWS & DOORS ARE TO THE CENTERLINE. (U.O.N.)

4. ALL DOOR JAMBS ON HINGE SIDE SHALL BE 4" U.O.N.

5. ALL ANGLED WALLS (OTHER THAN 90 DEGREES) SHALL BE 45 DEGREES U.O.N.

10. PROVIDE ACCOUSTICAL PIPE WRAP AT ALL SECOND FLOOR WASTE LINES.

6. ALL EXTERIOR WALLS SHALL BE CONSTRUCTED OF 2"X6" 16" O.C. STUDS, U.O.N., S.S.D. 7. ALL INTERIOR WALLS SHALL BE CONSTRUCTED OF 2'X4' 16" O.C. STUDS, U.O.N., S.S.D. 8. SUB-CONTRACTOR SHALL INSURE THAT ALL WORK IS DONE IN A PROFESSIONAL WORKMANLIKE MANNER BY SKILLED MECHANICS AND SHALL REPLACE ANY MATERIALS OR ITEMS DAMAGED BY SUB-CONTRACTORS PERFORMANCE. SUB-CONTRACTORS AND SUPPLIERS ARE HEREBY NOTIFIED THAT THEY ARE TO CONFER AND COOPERATE FULLY WITH EACH OTHER DURING THE COURSE OF CONSTRUCTION TO DETERMINE THE EXACT EXTENT AND OVERLAP OF EACH OTHER'S WORK AND TO SUCCESSFULLY

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RESPONSIBLE FOR CLEANING UP AND REMOVING FROM THE JOB SITE ALL TRASH AND DEBRIS NOT LEFT SUB-CONTRACTORS. BUILDER WILL DETERMINE HOW SOON AFTER SUB-CONTRACTOR COMPLETES EACH PHASE OF HIS WORK THAT TRASH AND DEBRIS WILL BE REMOVED FROM THE SITE. 9. ALL TEMPERED GLASS SHALL BE AFFIXED WITH A PERMANENT LABEL PER 2019

11. TILE INSTALLATION SHALL COMPLY W/ APPLICABLE SECTIONS OF THE TILE COUNCIL OF NORTH AMERICA'S "HANDBOOK FOR CERAMIC TILE INSTALLATION" AND ITS REFERENCED STANDARDS. 12. ALL COUNTERS, TUB DECKS & WALLS AT TUBS & SHOWERS SHALL HAVE SMOOTH, HARD, NONABSORBENT SURFACE O/ CEMENTITIOUS BACKER BOARD AND A MOISTURE RESISTANT UNDERLAYMENT TO 13. PROVIDE BACKING FOR ALL WALL AND CEILING MOUNTED CABINETS, FIXTURES, CABINETS, BRACKET,

GRAB BARS, ETC. AS REQUIRED. COORDINATE WITH SUPPLIERS FOR REQUIREMENTS. 14. CALCULATIONS AND DETAILS FOR MOUNTING HANDRAILS & CONNECTION OF GUARDRAILS SHALL BE PROVIDED FOR REVIEW AND APPROVAL BY RAILING FABRICATOR PRIOR TO INSTALLATION FOR COMPLIANCE WITH 2019 15. VERIFY APPLIANCE DIMENSIONS PRIOR TO CABINET FABRICATION
16. 1 LAYER 1/2" GYP. BD. ON ALL WALLS OF GARAGE. CRC R308.1. A HEIGHT OF +72" ABOVE FLOOR PER

2019 CRC R307.2 CRC TABLE R301.5 2019 CRC TABLE R302.6 (2019 CRC R311.7.5.1). 17. A DRAFT STOPS TO BE PROVIDED IN THE FLOOR/CEILING ASSEMBLIES AND ATTIC (CBC SECTIONS 718.3.3 AND 718.4.3 AND R302.12). DRAFT STOPPING SHALL DIVIDE THE CONCEALED SPACE INTO APROXIMATELY EQUAL AREAS. CBC 718.4.3 DRAFTSTOPPING SHALL BE INSTALLED IN ATTICS AND CONCEALED ROOF SPACES, SUCH THAT ANY HORIZONTAL AREA DOES NOT EXCEED 3,000 SQ. FT. CONTRACTOR TO VERIFY IN FIELD. 18. EXTERIOR DOORS: RECESS CONCRETE (WHERE OCCURS) AT DOOR THRESHOLDS TO MINIMIZE THRESHOLD HEIGHT - COORDINATE WITH FLOORING (WOOD, CARPET, OR EXPOSED CONCRETE, ETC).

THRESHOLD MUST COMPLY WITH MANUFACTURER'S WEATHER-PROOFING REQUIREMENT

19. 2" RECESS. RECESS FOUNDATION AT ALL RECESSED DOORS.

CONSULT MANUFACTURER FOR ANY THRESHOLD REQUIEMENTS FOR CONCRETE SLAB APPLICATIONS.

WALL LEGEND:

8" CONCRETE

HATCH PATTERNS: DROPPED CEILING | - - - 7 OR SOFFIT

SQUARE FOOTAGE BREAKDOWN: MAIN LEVEL FLOOR PLAN

LOWER LEVEL 3 269 SQ.FT. **GROUND LEVEL** 2 666 SQ.FT.

3-CAR GARAGE COURTYARD COVERED BALCONY COVERED DECK #1 584 1 204 SQ.FT. COVERED DECK #2 COVERED MASTER PATIO 174 SQ.FT. 2 300 STORAGE #1 STORAGE #2 SQ.FT. UNCONDITIONED 579 SQ.FT. STORAGE

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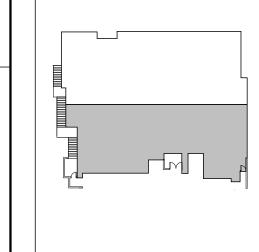
DESIGNS

KRISHNA RESIDENCE

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072-2740-018-0000

KEY PLAN:



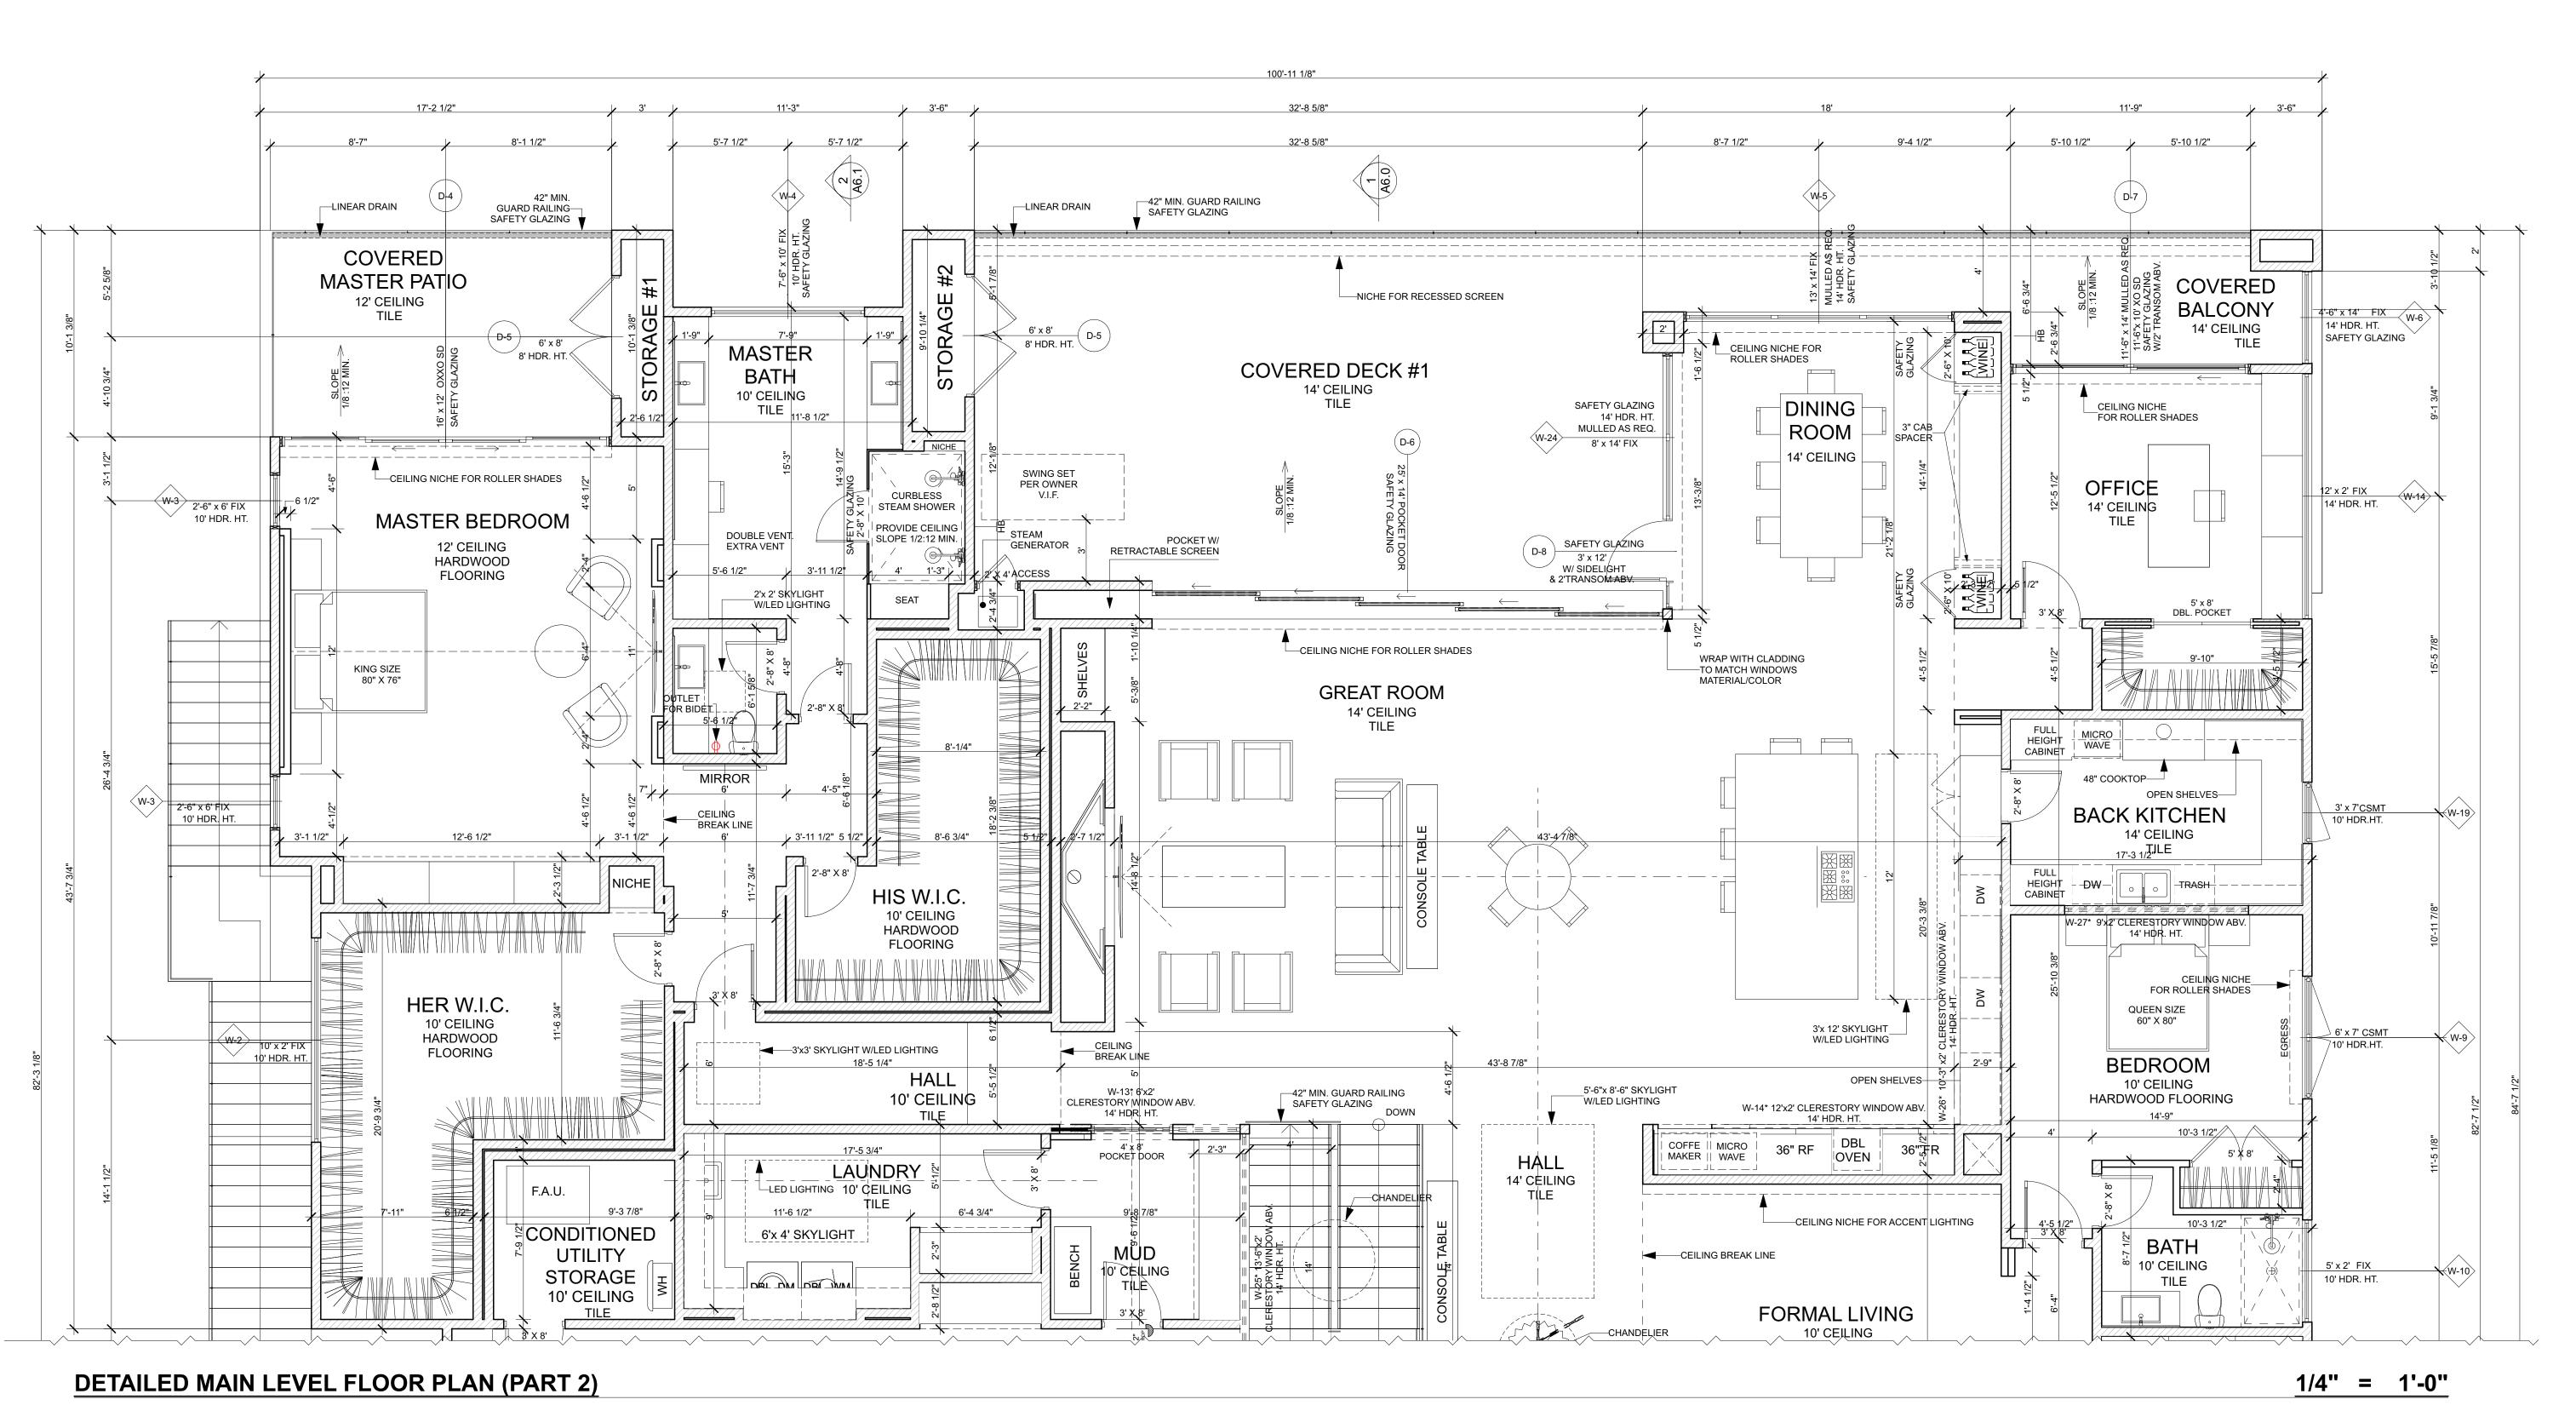
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FLOOR PLAN (PART1)

SHEET TITLE: DETAILED MAIN LEVEL



1. ALL EXTERIOR DIMENSIONS TO FACE OF STUD, FACE OF FOUNDATION, & FACE OF STOREFRONT (U.O.N.) 2. ALL INTERIOR DIMENSIONS TO FACE OF STUD (U.O.N.) 3. ALL DIMENSIONS AT WINDOWS & DOORS ARE TO THE CENTERLINE. (U.O.N.)

- 4. ALL DOOR JAMBS ON HINGE SIDE SHALL BE 4" U.O.N.
- 5. ALL ANGLED WALLS (OTHER THAN 90 DEGREES) SHALL BE 45 DEGREES U.O.N.
- 6. ALL EXTERIOR WALLS SHALL BE CONSTRUCTED OF 2"X6" 16" O.C. STUDS, U.O.N., S.S.D. 7. ALL INTERIOR WALLS SHALL BE CONSTRUCTED OF 2'X4' 16" O.C. STUDS, U.O.N., S.S.D. 8. SUB-CONTRACTOR SHALL INSURE THAT ALL WORK IS DONE IN A PROFESSIONAL WORKMANLIKE MANNER BY SKILLED MECHANICS AND SHALL REPLACE ANY MATERIALS OR ITEMS DAMAGED BY SUB-CONTRACTORS PERFORMANCE. SUB-CONTRACTORS AND SUPPLIERS ARE HEREBY NOTIFIED THAT THEY ARE TO CONFER AND COOPERATE FULLY WITH EACH OTHER DURING THE COURSE OF CONSTRUCTION TO DETERMINE THE EXACT EXTENT AND OVERLAP OF EACH OTHER'S WORK AND TO SUCCESSFULLY
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- SUB-CONTRACTORS. BUILDER WILL DETERMINE HOW SOON AFTER SUB-CONTRACTOR COMPLETES EACH PHASE OF HIS WORK THAT TRASH AND DEBRIS WILL BE REMOVED FROM THE SITE. 9. ALL TEMPERED GLASS SHALL BE AFFIXED WITH A PERMANENT LABEL PER 2019 10. PROVIDE ACCOUSTICAL PIPE WRAP AT ALL SECOND FLOOR WASTE LINES.
- 11. TILE INSTALLATION SHALL COMPLY W/ APPLICABLE SECTIONS OF THE TILE COUNCIL OF NORTH AMERICA'S "HANDBOOK FOR CERAMIC TILE INSTALLATION" AND ITS REFERENCED STANDARDS. 12. ALL COUNTERS, TUB DECKS & WALLS AT TUBS & SHOWERS SHALL HAVE SMOOTH, HARD, NONABSORBENT SURFACE O/ CEMENTITIOUS BACKER BOARD AND A MOISTURE RESISTANT UNDERLAYMENT TO 13. PROVIDE BACKING FOR ALL WALL AND CEILING MOUNTED CABINETS, FIXTURES, CABINETS, BRACKET,
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THRESHOLD MUST COMPLY WITH MANUFACTURER'S WEATHER-PROOFING REQUIREMENT

19. 2" RECESS. RECESS FOUNDATION AT ALL RECESSED DOORS.

WALL LEGEND: HATCH PATTERNS: DROPPED CEILING F - - 7 2"X4" @16" O.C. OR SOFFIT L _ _ J CONCRETE 8" CONCRETE

SQUARE FOOTAGE B	REAKDO	<u> </u>	
MAIN LEVEL FLOOR PLAN	5 382	SQ.FT.	3-CAR GARAGE
LOWER LEVEL	3 269	SQ.FT.	COURTYARD COVERED BALCONY
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			PATIO
			STORAGE #1
			STORAGE #2
			UNCONDITIONED STORAGE

SQ.FT. SQ.FT. SQ.FT.

SQ.FT.

SQ.FT.

SQ.FT.

SQ.FT.

DESIGNS

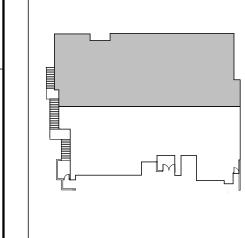
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KRISHNA RESIDENCE

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KEY PLAN:



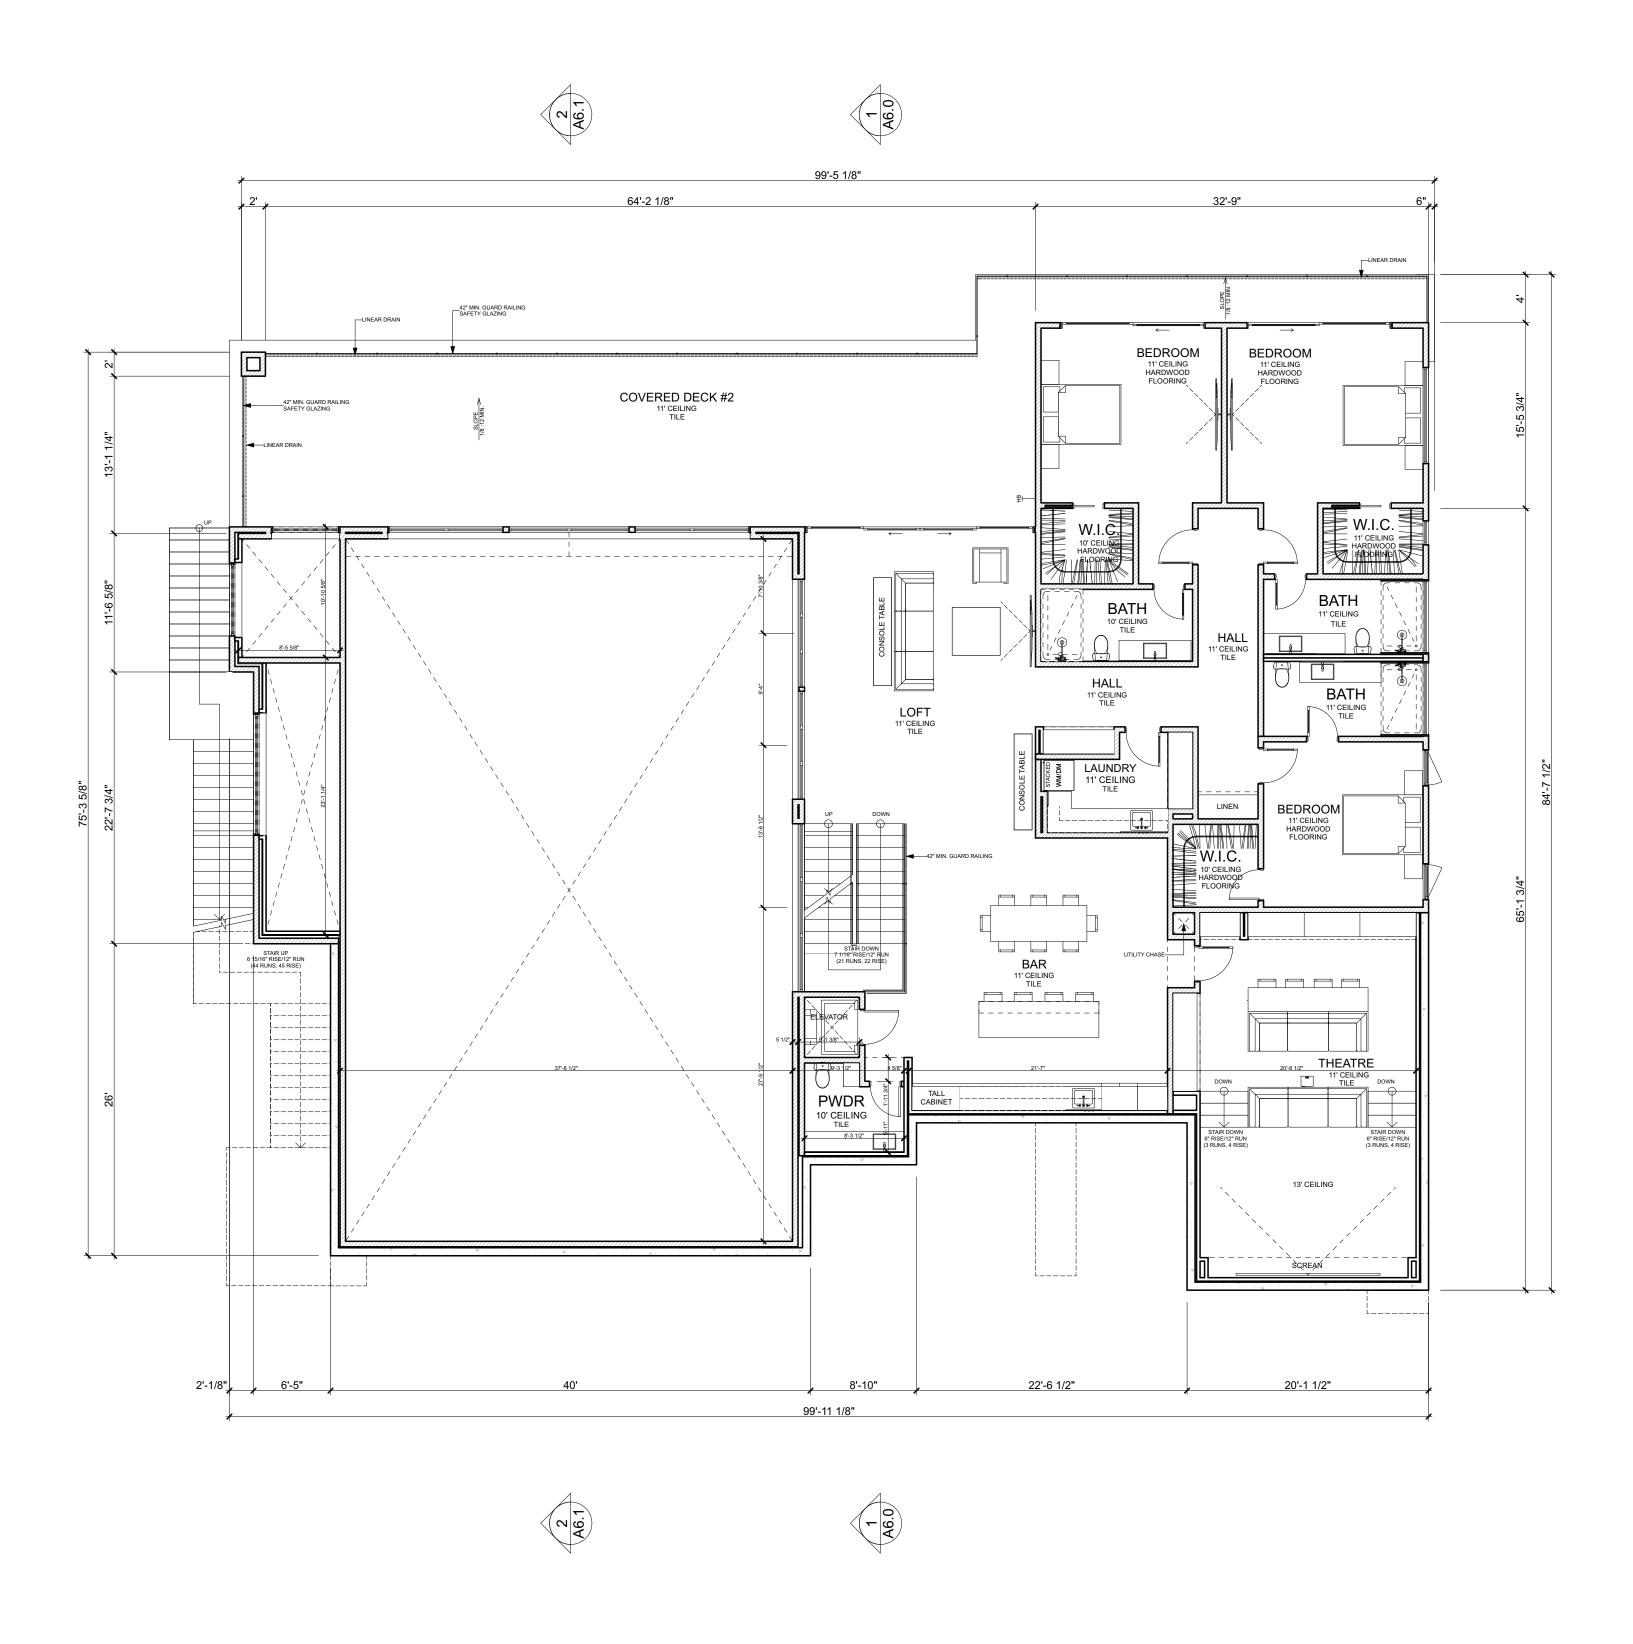
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SHEET TITLE: DETAILED MAIN LEVEL FLOOR PLAN (PART 2)

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1. ALL EXTERIOR DIMENSIONS TO FACE OF STUD, FACE OF FOUNDATION, & FACE OF STOREFRONT (U.O.N.) 2. ALL INTERIOR DIMENSIONS TO FACE OF STUD (U.O.N.)

3. ALL DIMENSIONS AT WINDOWS & DOORS ARE TO THE CENTERLINE. (U.O.N.)

4. ALL DOOR JAMBS ON HINGE SIDE SHALL BE 4" U.O.N.
5. ALL ANGLED WALLS (OTHER THAN 90 DEGREES) SHALL BE 45 DEGREES U.O.N.

6. ALL EXTERIOR WALLS SHALL BE CONSTRUCTED OF 2"X6" 16" O.C. STUDS, U.O.N., S.S.D. 7. ALL INTERIOR WALLS SHALL BE CONSTRUCTED OF 2'X4' 16" O.C. STUDS, U.O.N., S.S.D.

8. SUB-CONTRACTOR SHALL INSURE THAT ALL WORK IS DONE IN A PROFESSIONAL WORKMANLIKE MANNER BY SKILLED MECHANICS AND SHALL REPLACE ANY MATERIALS OR ITEMS DAMAGED BY SUB-CONTRACTORS PERFORMANCE. SUB-CONTRACTORS AND SUPPLIERS ARE HEREBY NOTIFIED THAT THEY ARE TO CONFER AND COOPERATE FULLY WITH EACH OTHER DURING THE COURSE OF CONSTRUCTION TO DETERMINE THE EXACT EXTENT AND OVERLAP OF EACH OTHER'S WORK AND TO SUCCESSFULLY COMPLETE THE EXECUTION OF THE

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10. PROVIDE ACCOUSTICAL PIPE WRAP AT ALL SECOND FLOOR WASTE LINES. 11. TILE INSTALLATION SHALL COMPLY W/ APPLICABLE SECTIONS OF THE TILE COUNCIL OF NORTH AMERICA'S "HANDBOOK FOR CERAMIC TILE INSTALLATION" AND ITS REFERENCED STANDARDS.

12. ALL COUNTERS, TUB DECKS & WALLS AT TUBS & SHOWERS SHALL HAVE SMOOTH, HARD, NONABSORBENT SURFACE O/ CEMENTITIOUS BACKER BOARD AND A MOISTURE RESISTANT

13. PROVIDE BACKING FOR ALL WALL AND CEILING MOUNTED CABINETS, FIXTURES, CABINETS, BRACKET, GRAB BARS, ETC. AS REQUIRED. COORDINATE WITH SUPPLIERS FOR REQUIREMENTS. 14. CALCULATIONS AND DETAILS FOR MOUNTING HANDRAILS & CONNECTION OF GUARDRAILS SHALL BE PROVIDED FOR REVIEW AND APPROVAL BY RAILING FABRICATOR PRIOR TO INSTALLATION FOR COMPLIANCE WITH 2019

15. VERIFY APPLIANCE DIMENSIONS PRIOR TO CABINET FABRICATION 16. 1 LAYER 1/2" GYP. BD. ON ALL WALLS OF GARAGE. CRC R308.1. A HEIGHT OF +72" ABOVE FLOOR PER 2019 CRC R307.2 CRC TABLE R301.5 2019 CRC TABLE R302.6 (2019 CRC R311.7.5.1). 17. A DRAFT STOPS TO BE PROVIDED IN THE FLOOR/CEILING ASSEMBLIES AND ATTIC (CBC SECTIONS

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WALL LEGEND:

2"X4" @16" O.C.	
2"X6" @16" O.C.	7//////
8" CONCRETE WALL	

HATCH PATTERNS:

DROPPED CEILING	Г — —
OR SOFFIT	L
CONCRETE LANDING	

SQUARE FOOTAGE BREAKDOWN:

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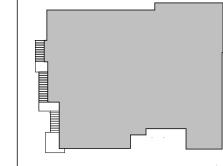
DESIGNS

KRISHNA RESIDENCE

421 TOBRURRY WAY FOLSOM CA 95630

072-2740-018-0000

KEY PLAN:



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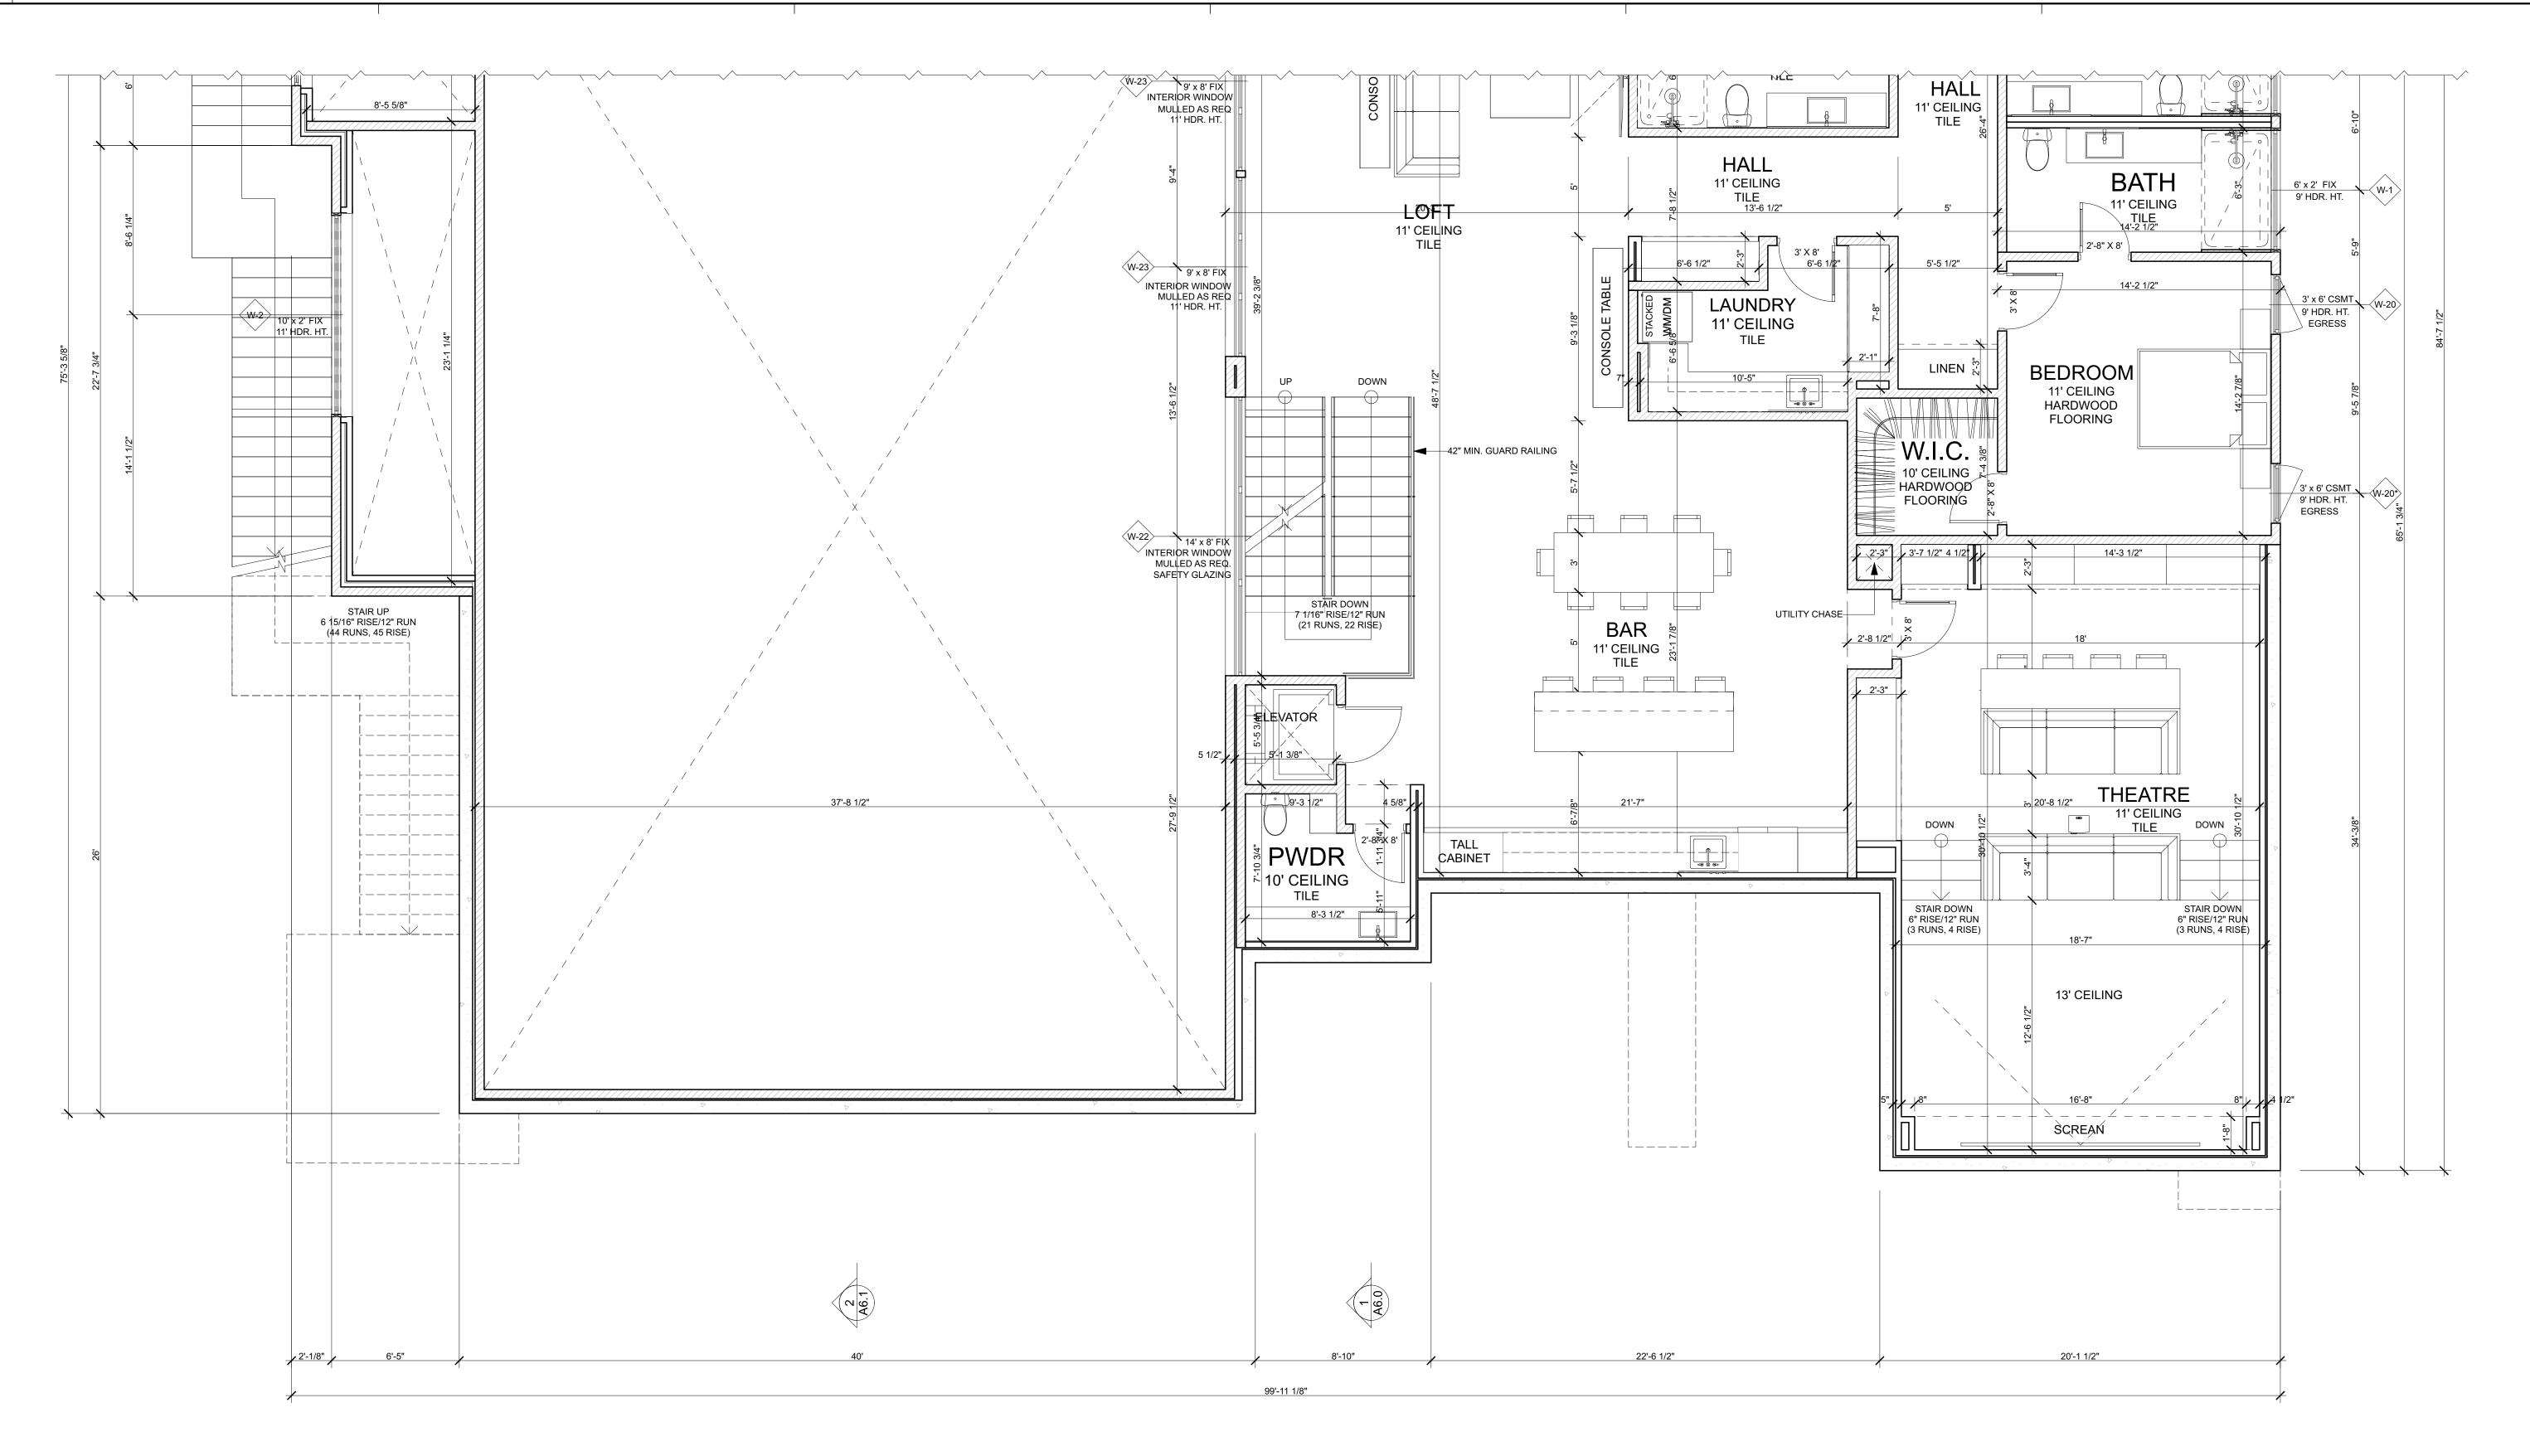
OVERALL LOWER LEVEL FLOOR PLAN

OVERALL LOWER LEVEL FLOOR PLAN

1/8" = 1'-0"

SQ.FT. SQ.FT. SQ.FT. SQ.FT. SQ.FT. SQ.FT. SQ.FT. SQ.FT.

SQ.FT.



DETAILED LOWER LEVEL FLOOR PLAN (PART 1)

1/4" = 1'-0"

FLOOR PLAN NOTES:

1. ALL EXTERIOR DIMENSIONS TO FACE OF STUD, FACE OF FOUNDATION, & FACE OF STOREFRONT (U.O.N.) 2. ALL INTERIOR DIMENSIONS TO FACE OF STUD (U.O.N.) 3. ALL DIMENSIONS AT WINDOWS & DOORS ARE TO THE CENTERLINE. (U.O.N.)

4. ALL DOOR JAMBS ON HINGE SIDE SHALL BE 4" U.O.N. 5. ALL ANGLED WALLS (OTHER THAN 90 DEGREES) SHALL BE 45 DEGREES U.O.N.

10. PROVIDE ACCOUSTICAL PIPE WRAP AT ALL SECOND FLOOR WASTE LINES.

6. ALL EXTERIOR WALLS SHALL BE CONSTRUCTED OF 2"X6" 16" O.C. STUDS, U.O.N., S.S.D.

7. ALL INTERIOR WALLS SHALL BE CONSTRUCTED OF 2'X4' 16" O.C. STUDS, U.O.N., S.S.D. 8. SUB-CONTRACTOR SHALL INSURE THAT ALL WORK IS DONE IN A PROFESSIONAL WORKMANLIKE MANNER BY SKILLED MECHANICS AND SHALL REPLACE ANY MATERIALS OR ITEMS DAMAGED BY SUB-CONTRACTORS PERFORMANCE. SUB-CONTRACTORS AND SUPPLIERS ARE HEREBY NOTIFIED THAT THEY ARE TO CONFER AND COOPERATE FULLY WITH EACH OTHER DURING THE COURSE OF CONSTRUCTION TO DETERMINE THE EXACT EXTENT AND OVERLAP OF EACH OTHER'S WORK AND TO SUCCESSFULLY

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8" CONCRETE

HATCH PATTERNS:

DROPPED CEILING Г — — ¬ OR SOFFIT L _ _ J

SQUARE FOOTAGE BREAKDOWN:

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COURTYARD COVERED BALCONY COVERED DECK #1 584 1 204 SQ.FT. COVERED DECK #2 COVERED MASTER PATIO 174 SQ.FT. 2 300 STORAGE #1 STORAGE #2 SQ.FT. UNCONDITIONED 579 SQ.FT. STORAGE

3-CAR GARAGE

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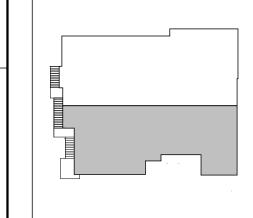
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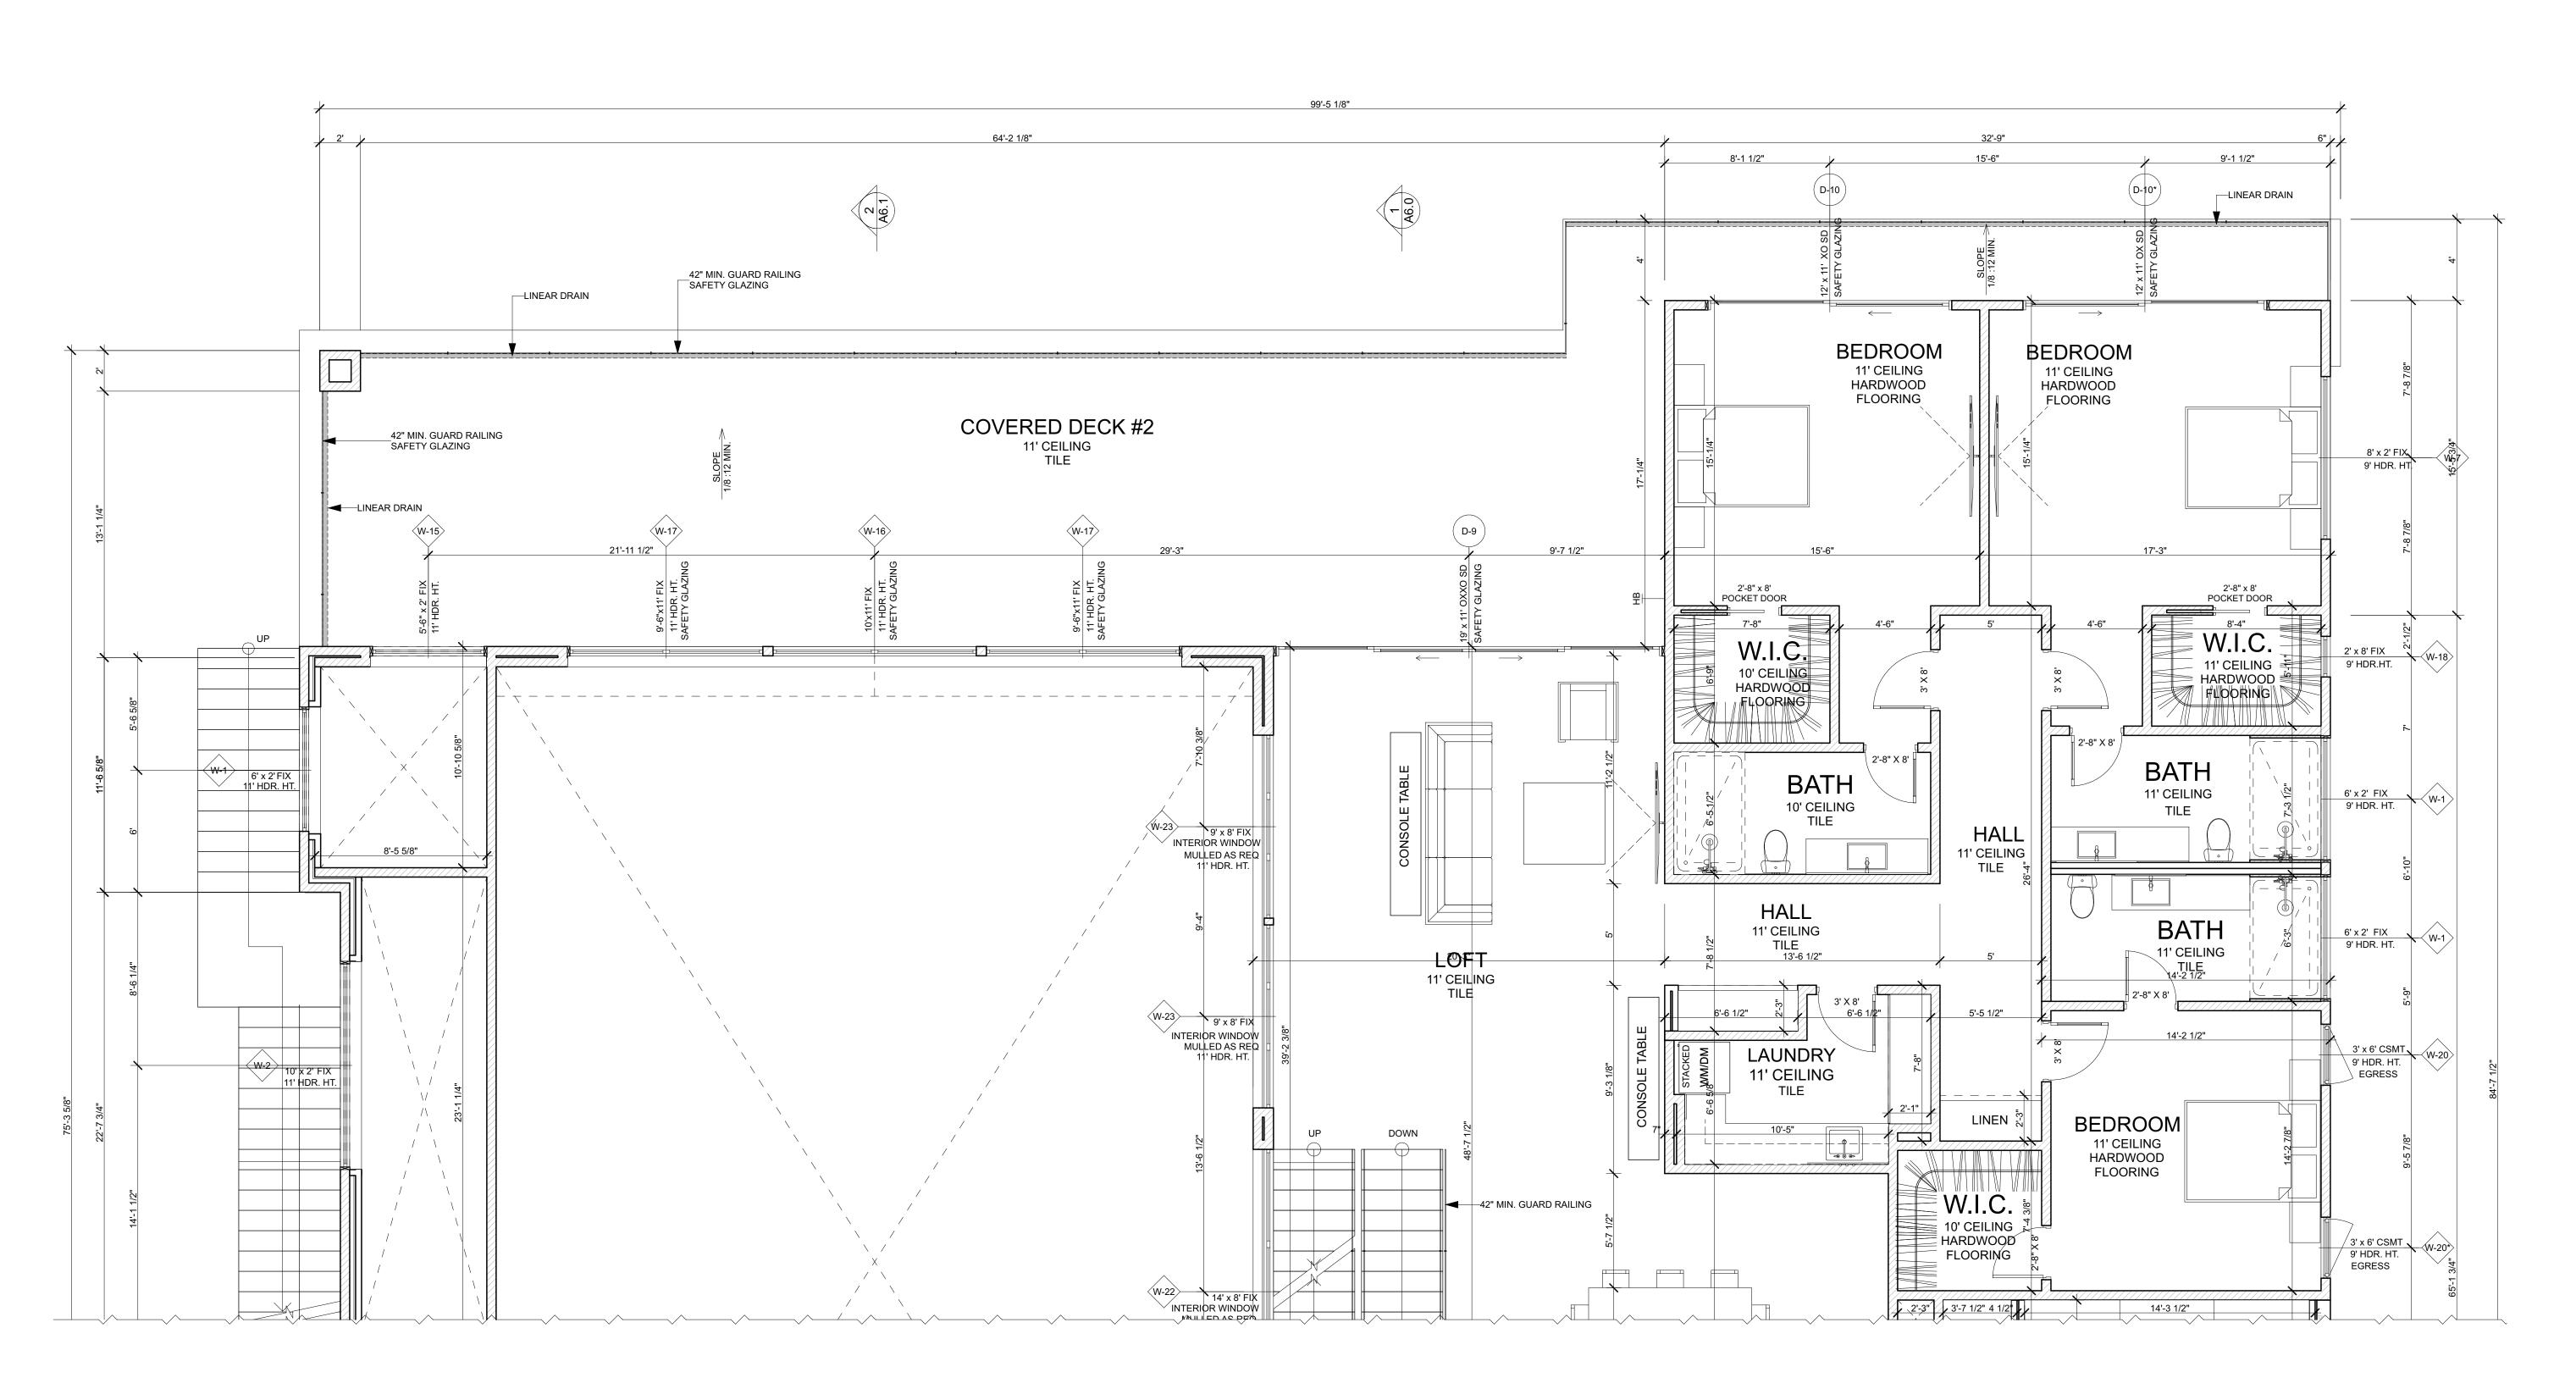
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DETAILED LOWER LEVEL FLOOR PLAN (PART 1)



DETAILED LOWER LEVEL FLOOR PLAN (PART 2)

1/4" = 1'-0"

FLOOR PLAN NOTES:

1. ALL EXTERIOR DIMENSIONS TO FACE OF STUD, FACE OF FOUNDATION, & FACE OF STOREFRONT (U.O.N.) 2. ALL INTERIOR DIMENSIONS TO FACE OF STUD (U.O.N.) 3. ALL DIMENSIONS AT WINDOWS & DOORS ARE TO THE CENTERLINE. (U.O.N.)

10. PROVIDE ACCOUSTICAL PIPE WRAP AT ALL SECOND FLOOR WASTE LINES.

4. ALL DOOR JAMBS ON HINGE SIDE SHALL BE 4" U.O.N.
5. ALL ANGLED WALLS (OTHER THAN 90 DEGREES) SHALL BE 45 DEGREES U.O.N.

6. ALL EXTERIOR WALLS SHALL BE CONSTRUCTED OF 2"X6" 16" O.C. STUDS, U.O.N., S.S.D. 7. ALL INTERIOR WALLS SHALL BE CONSTRUCTED OF 2'X4' 16" O.C. STUDS, U.O.N., S.S.D. 8. SUB-CONTRACTOR SHALL INSURE THAT ALL WORK IS DONE IN A PROFESSIONAL WORKMANLIKE MANNER BY SKILLED MECHANICS AND SHALL REPLACE ANY MATERIALS OR ITEMS DAMAGED BY SUB-CONTRACTORS PERFORMANCE. SUB-CONTRACTORS AND SUPPLIERS ARE HEREBY NOTIFIED THAT THEY ARE TO CONFER AND COOPERATE FULLY WITH EACH OTHER DURING THE COURSE OF CONSTRUCTION TO DETERMINE THE EXACT EXTENT AND OVERLAP OF EACH OTHER'S WORK AND TO SUCCESSFULLY

COMPLETE THE EXECUTION OF THE WORK. ALL SUB-CONTRACTOR WORKMANSHIP WILL BE OF QUALITY TO PASS INSPECTIONS BY LOCAL AUTHORITIES, LENDING INSTITUTIONS, ARCHITECT/DESIGNER, OR BUILDER. ANY ONE OR ALL OF THE ABOVE MENTIONED INSPECTORS MAY INSPECT WORKMANSHIP AT ANY TIME, AND ANY CORRECTIONS NEEDED TO ENHANCE THE QUALITY OF BUILDING WILL BE DONE IMMEDIATELY. EACH SUB-CONTRACTOR, UNLESS PECIFICALLY EXEMPTED BY THE TERMS OF HIS SUB-CONTRACT AGREEMENT, SHALL BE RESPONSIBLE FOR CLEANING UP AND REMOVING FROM THE JOB SITE ALL TRASH AND DEBRIS NOT LEFT

SUB-CONTRACTORS. BUILDER WILL DETERMINE HOW SOON AFTER SUB-CONTRACTOR COMPLETES EACH PHASE OF HIS WORK THAT TRASH AND DEBRIS WILL BE REMOVED FROM THE SITE. 9. ALL TEMPERED GLASS SHALL BE AFFIXED WITH A PERMANENT LABEL PER 2019

11. TILE INSTALLATION SHALL COMPLY W/ APPLICABLE SECTIONS OF THE TILE COUNCIL OF NORTH AMERICA'S "HANDBOOK FOR CERAMIC TILE INSTALLATION" AND ITS REFERENCED STANDARDS. 12. ALL COUNTERS, TUB DECKS & WALLS AT TUBS & SHOWERS SHALL HAVE SMOOTH, HARD, NONABSORBENT SURFACE O/ CEMENTITIOUS BACKER BOARD AND A MOISTURE RESISTANT UNDERLAYMENT TO 13. PROVIDE BACKING FOR ALL WALL AND CEILING MOUNTED CABINETS, FIXTURES, CABINETS, BRACKET, GRAB BARS, ETC. AS REQUIRED. COORDINATE WITH SUPPLIERS FOR REQUIREMENTS.

14. CALCULATIONS AND DETAILS FOR MOUNTING HANDRAILS & CONNECTION OF GUARDRAILS SHALL BE PROVIDED FOR REVIEW AND APPROVAL BY RAILING FABRICATOR PRIOR TO INSTALLATION FOR COMPLIANCE WITH 2019 15. VERIFY APPLIANCE DIMENSIONS PRIOR TO CABINET FABRICATION
16. 1 LAYER 1/2" GYP. BD. ON ALL WALLS OF GARAGE. CRC R308.1. A HEIGHT OF +72" ABOVE FLOOR PER 2019 CRC R307.2 CRC TABLE R301.5 2019 CRC TABLE R302.6 (2019 CRC R311.7.5.1). 17. A DRAFT STOPS TO BE PROVIDED IN THE FLOOR/CEILING ASSEMBLIES AND ATTIC (CBC SECTIONS

718.3.3 AND 718.4.3 AND R302.12). DRAFT STOPPING SHALL DIVIDE THE CONCEALED SPACE INTO APROXIMATELY EQUAL AREAS. CBC 718.4.3 DRAFTSTOPPING SHALL BE INSTALLED IN ATTICS AND CONCEALED ROOF SPACES, SUCH THAT ANY HORIZONTAL AREA DOES NOT EXCEED 3,000 SQ. FT. CONTRACTOR TO VERIFY IN FIELD. 18. EXTERIOR DOORS: RECESS CONCRETE (WHERE OCCURS) AT DOOR THRESHOLDS TO MINIMIZE THRESHOLD HEIGHT - COORDINATE WITH FLOORING (WOOD, CARPET, OR EXPOSED CONCRETE, ETC). CONSULT MANUFACTURER FOR ANY THRESHOLD REQUIEMENTS FOR CONCRETE SLAB APPLICATIONS. THRESHOLD MUST COMPLY WITH MANUFACTURER'S WEATHER-PROOFING REQUIREMENT

19. 2" RECESS. RECESS FOUNDATION AT ALL RECESSED DOORS.

WALL LEGEND:

8" CONCRETE

HATCH PATTERNS:

DROPPED CEILING Г — — ¬ OR SOFFIT L _ _ J

SQUARE FOOTAGE BREAKDOWN:

	11 317	SQ.FT.
GROUND LEVEL	2 666	SQ.FT.
LOWER LEVEL	3 269	SQ.FT.
MAIN LEVEL FLOOR PLAN	5 382	SQ.F1.

COVERED BALCONY SQ.FT. SQ.FT. COVERED DECK #1 584 1 204 COVERED DECK #2 COVERED MASTER PATIO 174 SQ.FT. 2 300 STORAGE #1 STORAGE #2 SQ.FT. UNCONDITIONED 579 SQ.FT. STORAGE

3-CAR GARAGE

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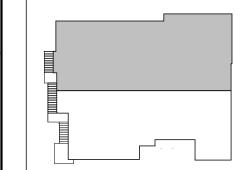
DESIGNS

KRISHNA RESIDENCE

421 TOBRURRY WAY FOLSOM CA 95630

072-2740-018-0000

KEY PLAN:



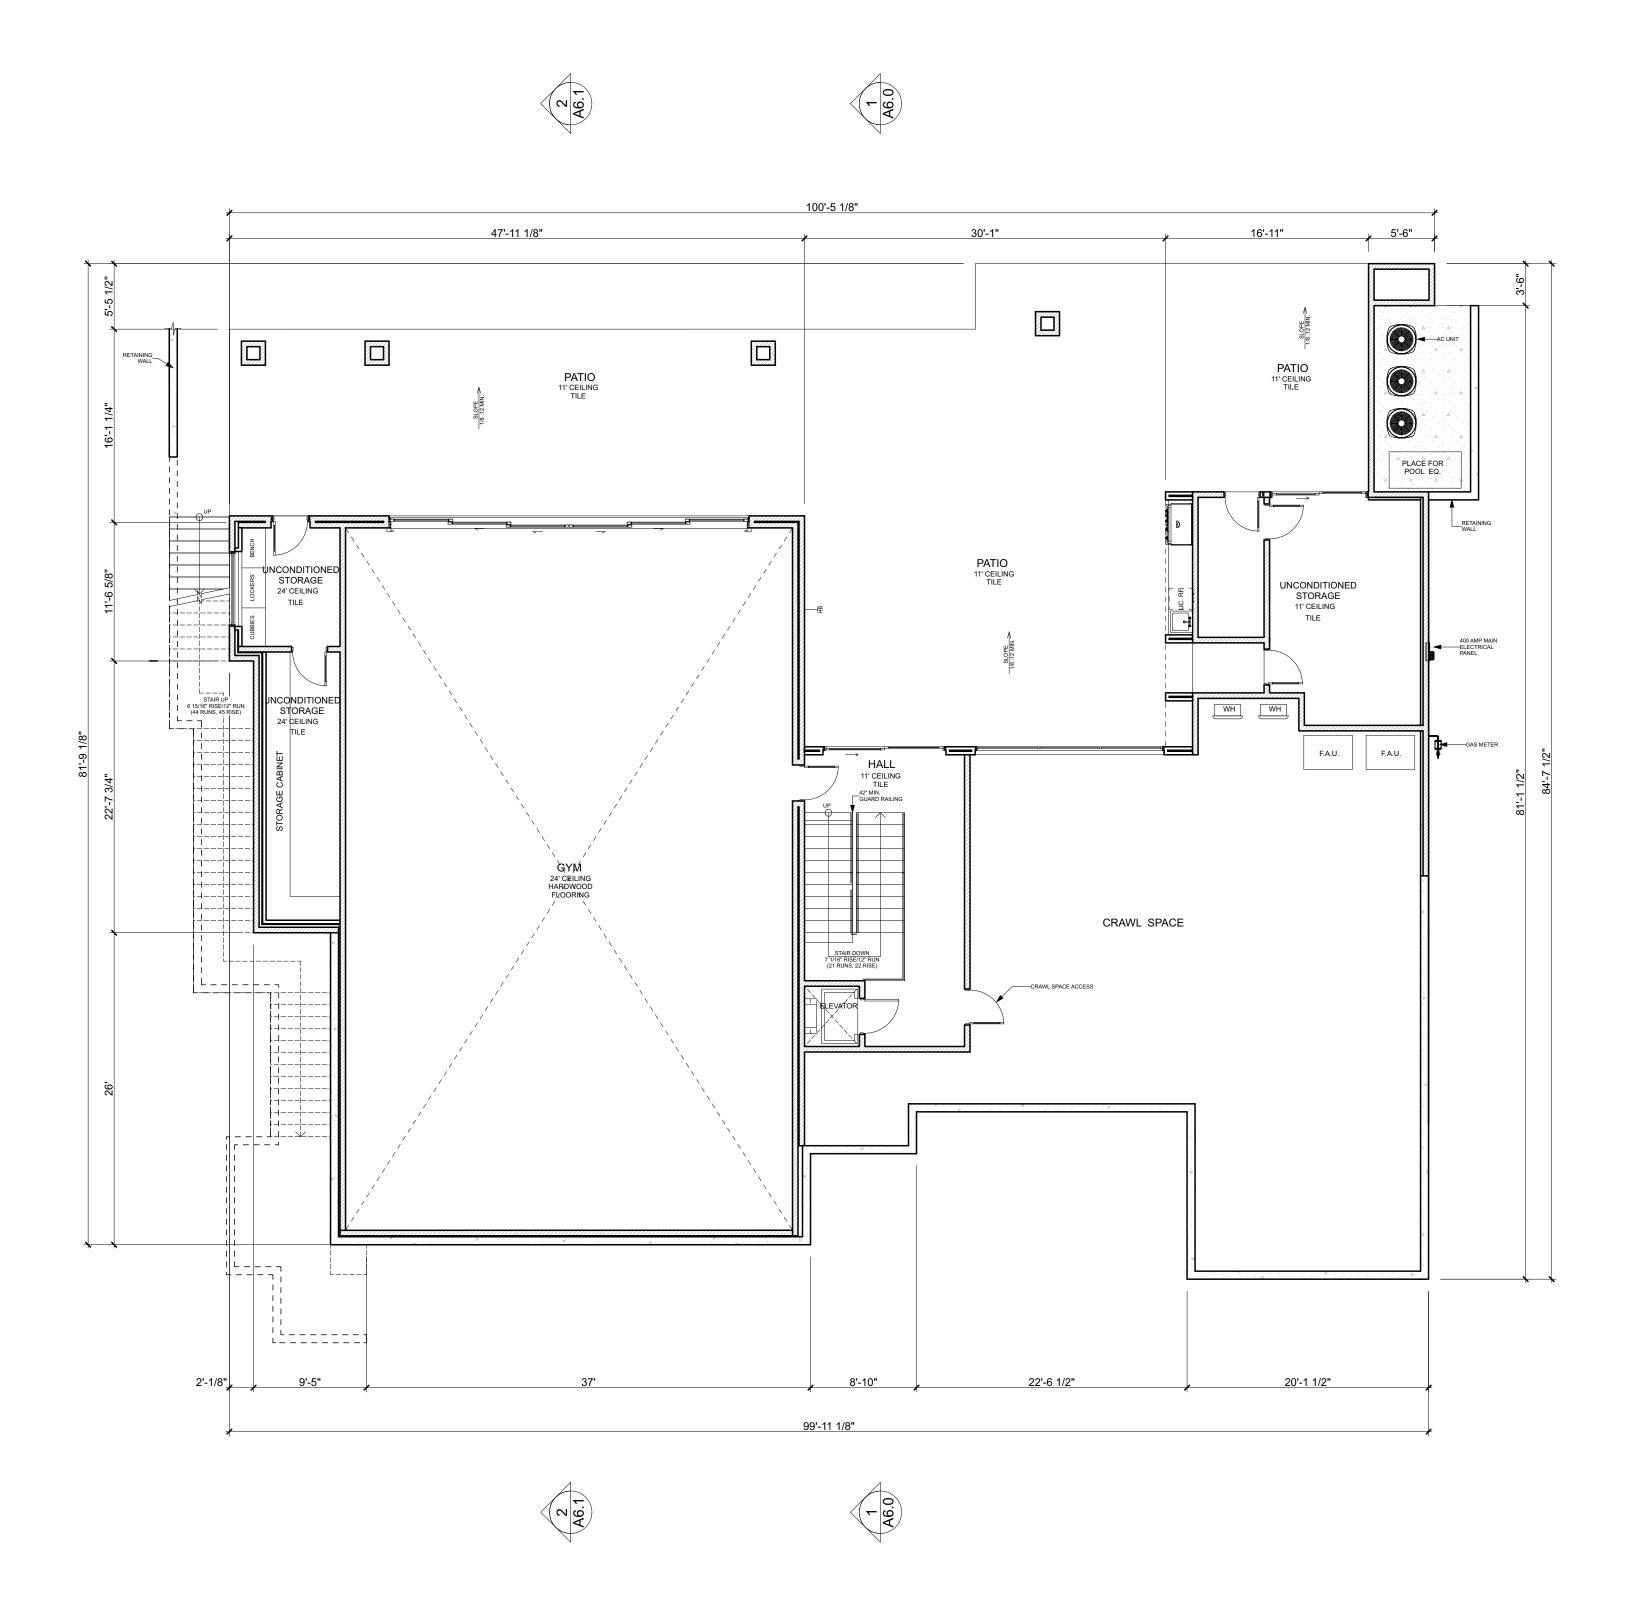
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DETAILED LOWER LEVEL FLOOR PLAN (PART 2)

SHEET TITLE:



1. ALL EXTERIOR DIMENSIONS TO FACE OF STUD, FACE OF FOUNDATION, & FACE OF STOREFRONT (U.O.N.) 2. ALL INTERIOR DIMENSIONS TO FACE OF STUD (U.O.N.)

3. ALL DIMENSIONS AT WINDOWS & DOORS ARE TO THE CENTERLINE. (U.O.N.)

4. ALL DOOR JAMBS ON HINGE SIDE SHALL BE 4" U.O.N.
5. ALL ANGLED WALLS (OTHER THAN 90 DEGREES) SHALL BE 45 DEGREES U.O.N.
6. ALL EXTERIOR WALLS SHALL BE CONSTRUCTED OF 2"X6" 10" O.C. STUDS, U.O.N., S.S.D.

7. ALL INTERIOR WALLS SHALL BE CONSTRUCTED OF 2'X4' 16" O.C. STUDS, U.O.N., S.S.D.

8. SUB-CONTRACTOR SHALL INSURE THAT ALL WORK IS DONE IN A PROFESSIONAL WORKMANLIKE MANNER BY SKILLED MECHANICS AND SHALL REPLACE ANY MATERIALS OR ITEMS DAMAGED BY SUB-CONTRACTORS PERFORMANCE. SUB-CONTRACTORS AND SUPPLIERS ARE HEREBY NOTIFIED THAT THEY ARE TO CONFER AND COOPERATE FULLY WITH EACH OTHER DURING THE COURSE OF CONSTRUCTION TO DETERMINE THE EXACT EXTENT AND OVERLAP OF EACH OTHER'S WORK AND TO SUCCESSFULLY COMPLETE THE EXECUTION OF THE

WORK. ALL SUB-CONTRACTOR WORKMANSHIP WILL BE OF QUALITY TO PASS INSPECTIONS BY LOCAL AUTHORITIES, LENDING INSTITUTIONS, ARCHITECT/DESIGNER, OR BUILDER. ANY ONE OR ALL OF THE ABOVE MENTIONED INSPECTORS MAY INSPECT WORKMANSHIP AT ANY TIME, AND ANY CORRECTIONS NEEDED TO ENHANCE THE QUALITY OF BUILDING WILL BE DONE IMMEDIATELY. EACH SUB-CONTRACTOR, UNLESS PECIFICALLY EXEMPTED BY THE TERMS OF HIS SUB-CONTRACT AGREEMENT, SHALL BE RESPONSIBLE FOR CLEANING UP AND REMOVING FROM THE JOB SITE ALL TRASH AND DEBRIS NOT LEFT BY OTHER

SUB-CONTRACTORS. BUILDER WILL DETERMINE HOW SOON AFTER SUB-CONTRACTOR COMPLETES EACH PHASE OF HIS WORK THAT TRASH AND DEBRIS WILL BE REMOVED FROM THE SITE. 9. ALL TEMPERED GLASS SHALL BE AFFIXED WITH A PERMANENT LABEL PER 2019

10. PROVIDE ACCOUSTICAL PIPE WRAP AT ALL SECOND FLOOR WASTE LINES. 11. TILE INSTALLATION SHALL COMPLY W/ APPLICABLE SECTIONS OF THE TILE COUNCIL OF NORTH AMERICA'S "HANDBOOK FOR CERAMIC TILE INSTALLATION" AND ITS REFERENCED STANDARDS.

12. ALL COUNTERS, TUB DECKS & WALLS AT TUBS & SHOWERS SHALL HAVE SMOOTH, HARD, NONABSORBENT SURFACE O/ CEMENTITIOUS BACKER BOARD AND A MOISTURE RESISTANT 13. PROVIDE BACKING FOR ALL WALL AND CEILING MOUNTED CABINETS, FIXTURES, CABINETS, BRACKET,

GRAB BARS, ETC. AS REQUIRED. COORDINATE WITH SUPPLIERS FOR REQUIREMENTS. 14. CALCULATIONS AND DETAILS FOR MOUNTING HANDRAILS & CONNECTION OF GUARDRAILS SHALL BE PROVIDED FOR REVIEW AND APPROVAL BY RAILING FABRICATOR PRIOR TO INSTALLATION FOR COMPLIANCE WITH 2019

15. VERIFY APPLIANCE DIMENSIONS PRIOR TO CABINET FABRICATION 16. 1 LAYER 1/2" GYP. BD. ON ALL WALLS OF GARAGE. CRC R308.1. A HEIGHT OF +72" ABOVE FLOOR PER 2019 CRC R307.2 CRC TABLE R301.5 2019 CRC TABLE R302.6 (2019 CRC R311.7.5.1). 17. A DRAFT STOPS TO BE PROVIDED IN THE FLOOR/CEILING ASSEMBLIES AND ATTIC (CBC SECTIONS 718.3.3 AND 718.4.3 AND R302.12). DRAFT STOPPING SHALL DIVIDE THE CONCEALED SPACE INTO APROXIMATELY EQUAL AREAS. CBC 718.4.3 DRAFTSTOPPING SHALL BE INSTALLED IN ATTICS AND

CONTRACTOR TO VERIFY IN FIELD. 18. EXTERIOR DOORS: RECESS CONCRETE (WHERE OCCURS) AT DOOR THRESHOLDS TO MINIMIZE THRESHOLD HEIGHT - COORDINATE WITH FLOORING (WOOD, CARPET, OR EXPOSED CONCRETE, ETC). CONSULT MANUFACTURER FOR ANY THRESHOLD REQUIEMENTS FOR CONCRETE SLAB APPLICATIONS. THRESHOLD MUST COMPLY WITH MANUFACTURER'S WEATHER-PROOFING REQUIREMENT

CONCEALED ROOF SPACES, SUCH THAT ANY HORIZONTAL AREA DOES NOT EXCEED 3,000 SQ. FT.

WALL LEGEND:

2"X4" @16" O.C. 8" CONCRETE

19. 2" RECESS. RECESS FOUNDATION AT ALL RECESSED DOORS.

HATCH PATTERNS:

OR SOFFIT L _ _ J CONCRETE

SQUARE FOOTAGE BREAKDOWN:

LOWER LEVEL 3 269 SQ.FT. 2 666 **GROUND LEVEL** 11 317

SQ.FT.
SQ.FT.
SQ.FT.
SQ.FT.
SQ.FT.
SQ.FT.
SQ.FT.
SQ.FT.
SQ.FT. 3-CAR GARAGE COURTYARD COURTYARD 106
COVERED BALCONY 170
COVERED DECK #1 584
COVERED DECK #2 1 204
COVERED MASTER PATIO 174
PATIO 2 300
STORAGE #1 27 STORAGE #1 STORAGE #2 UNCONDITIONED 579 SQ.FT. STORAGE

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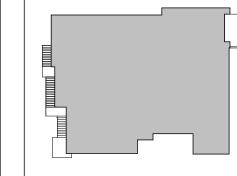
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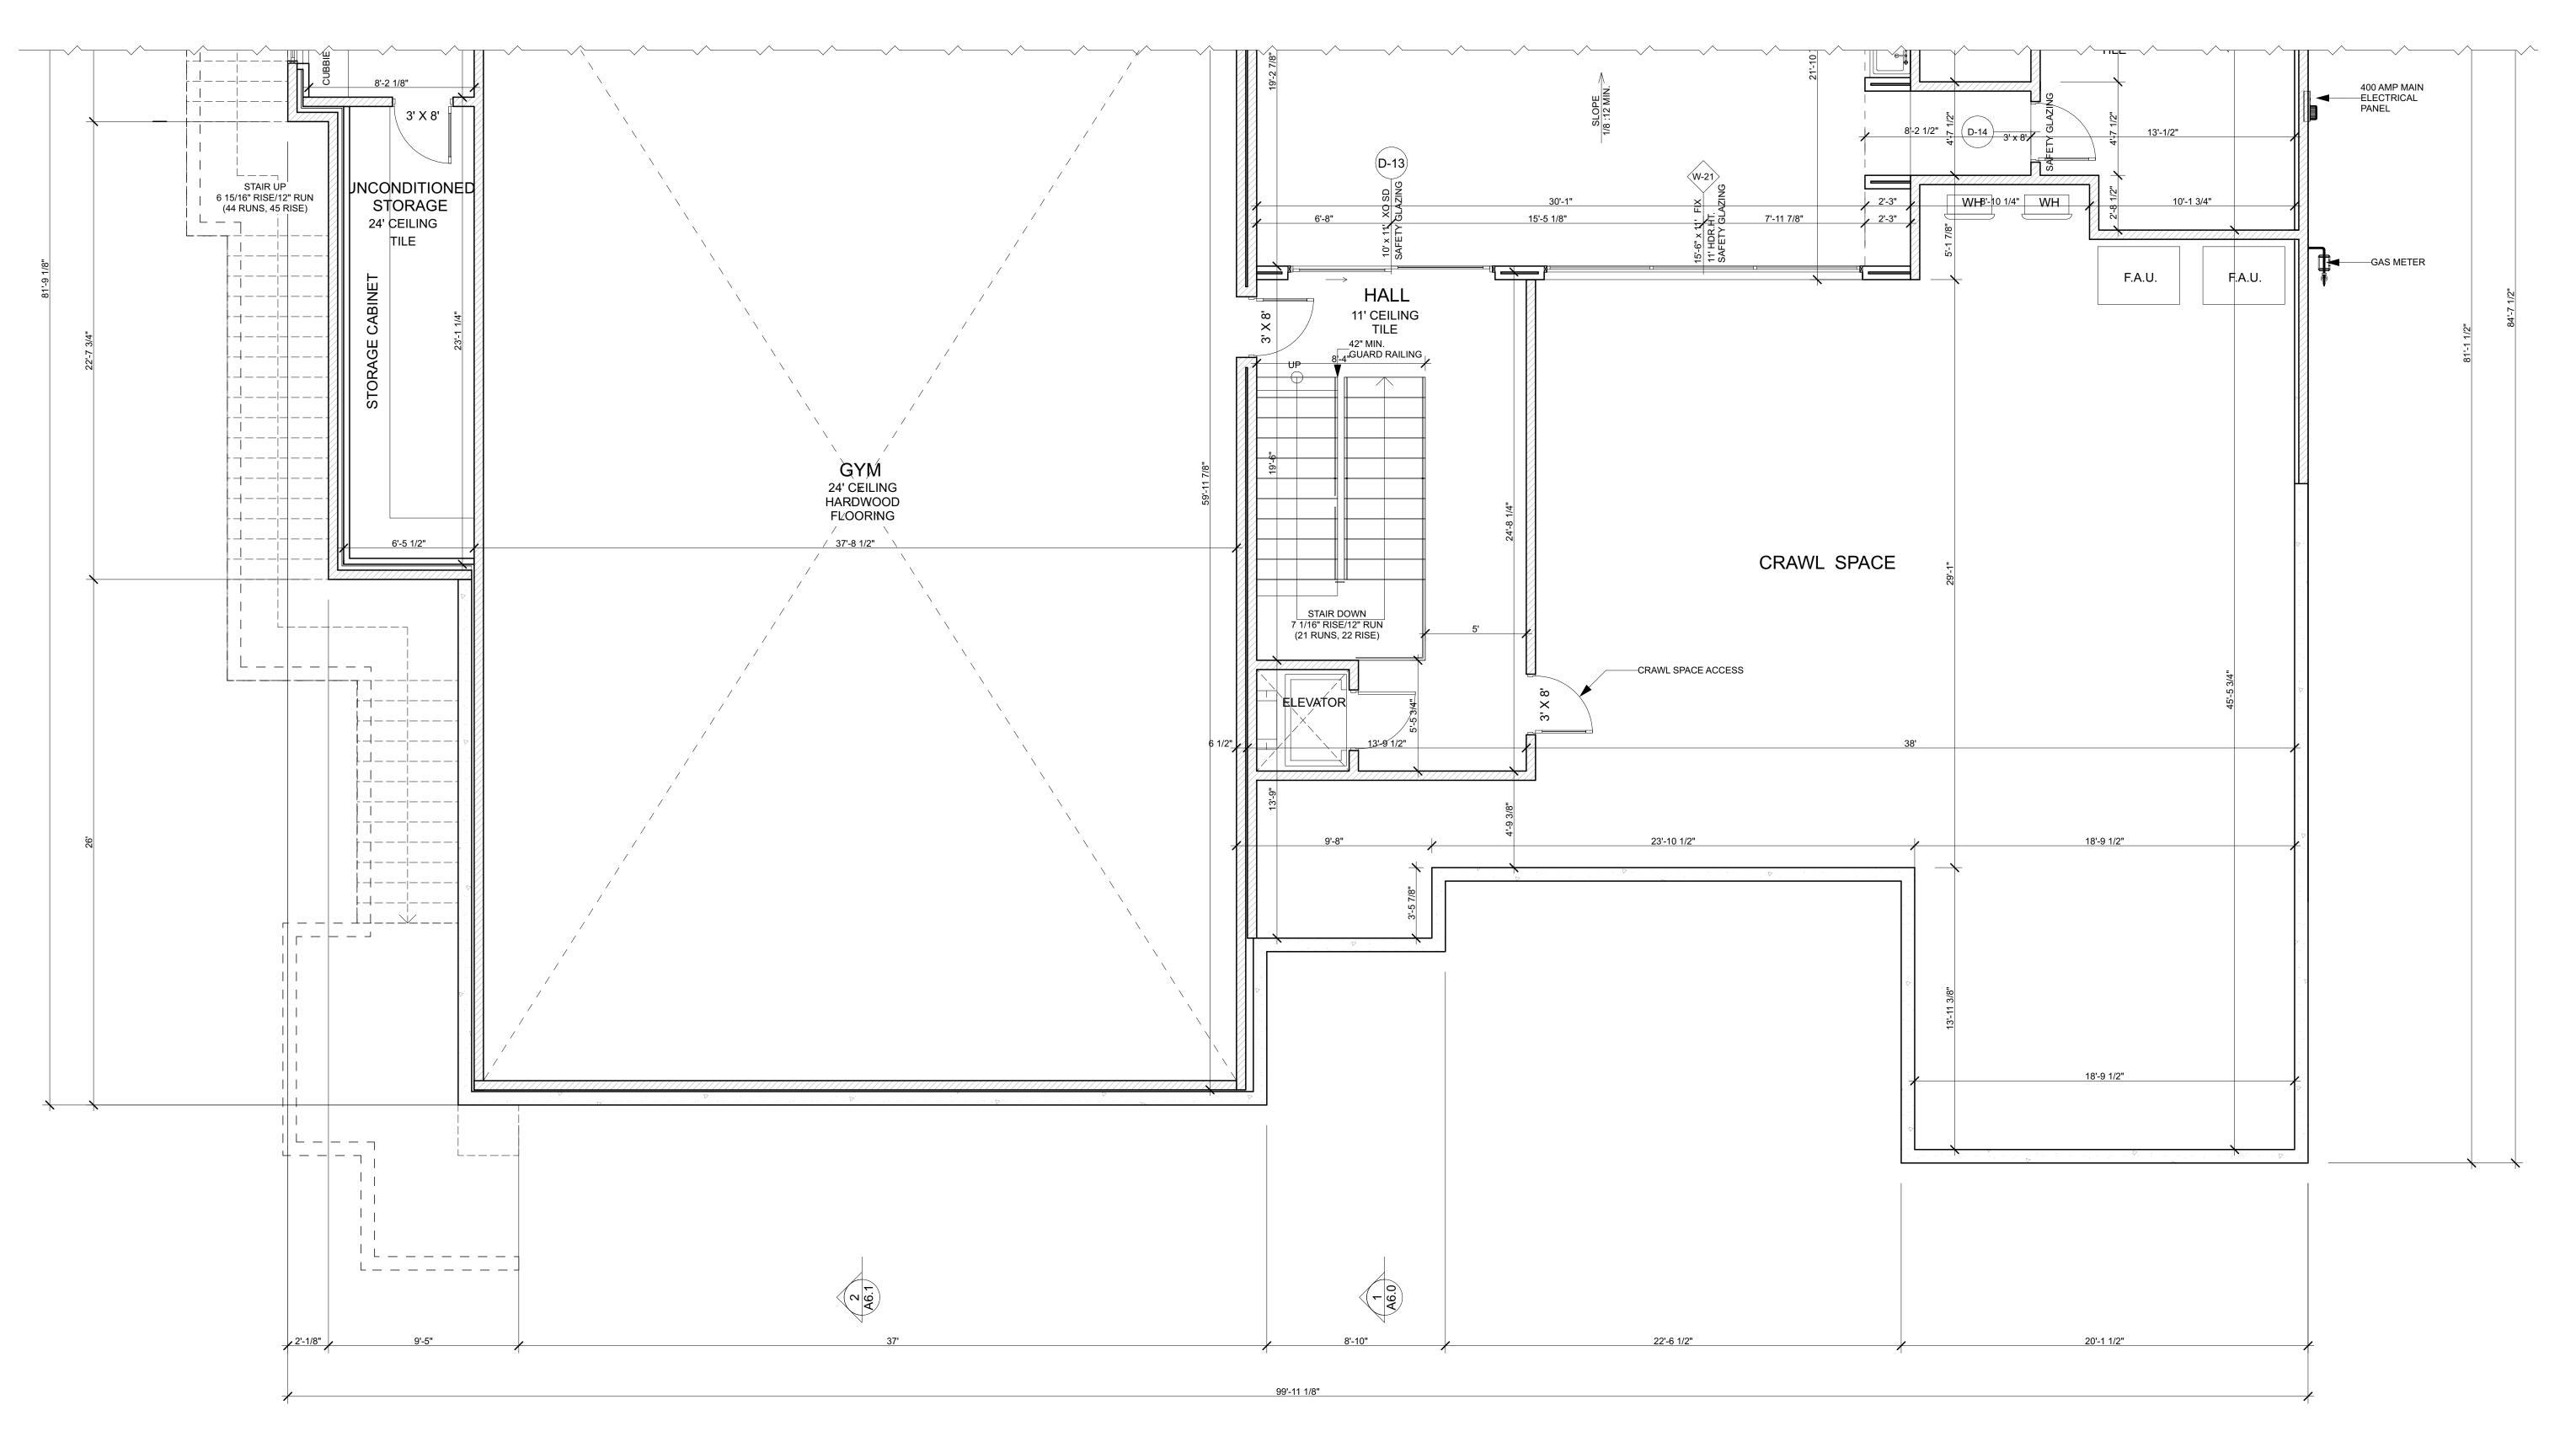
KEY PLAN:



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OVERALL GROUND LEVEL FLOOR PLAN



DETAILED GROUND LEVEL FLOOR PLAN (PART 1)

1/4" = 1'-0"

FLOOR PLAN NOTES:

1. ALL EXTERIOR DIMENSIONS TO FACE OF STUD, FACE OF FOUNDATION, & FACE OF STOREFRONT (U.O.N.) 2. ALL INTERIOR DIMENSIONS TO FACE OF STUD (U.O.N.) 3. ALL DIMENSIONS AT WINDOWS & DOORS ARE TO THE CENTERLINE. (U.O.N.)

4. ALL DOOR JAMBS ON HINGE SIDE SHALL BE 4" U.O.N.

5. ALL ANGLED WALLS (OTHER THAN 90 DEGREES) SHALL BE 45 DEGREES U.O.N. 6. ALL EXTERIOR WALLS SHALL BE CONSTRUCTED OF 2"X6" 16" O.C. STUDS, U.O.N., S.S.D.

7. ALL INTERIOR WALLS SHALL BE CONSTRUCTED OF 2'X4' 16" O.C. STUDS, U.O.N., S.S.D. 8. SUB-CONTRACTOR SHALL INSURE THAT ALL WORK IS DONE IN A PROFESSIONAL WORKMANLIKE MANNER BY SKILLED MECHANICS AND SHALL REPLACE ANY MATERIALS OR ITEMS DAMAGED BY SUB-CONTRACTORS PERFORMANCE. SUB-CONTRACTORS AND SUPPLIERS ARE HEREBY NOTIFIED THAT THEY ARE TO CONFER AND COOPERATE FULLY WITH EACH OTHER DURING THE COURSE OF CONSTRUCTION TO DETERMINE THE EXACT EXTENT AND OVERLAP OF EACH OTHER'S WORK AND TO SUCCESSFULLY

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SUB-CONTRACTORS. BUILDER WILL DETERMINE HOW SOON AFTER SUB-CONTRACTOR COMPLETES EACH PHASE OF HIS WORK THAT TRASH AND DEBRIS WILL BE REMOVED FROM THE SITE. 9. ALL TEMPERED GLASS SHALL BE AFFIXED WITH A PERMANENT LABEL PER 2019 10. PROVIDE ACCOUSTICAL PIPE WRAP AT ALL SECOND FLOOR WASTE LINES.

11. TILE INSTALLATION SHALL COMPLY W/ APPLICABLE SECTIONS OF THE TILE COUNCIL OF NORTH AMERICA'S "HANDBOOK FOR CERAMIC TILE INSTALLATION" AND ITS REFERENCED STANDARDS. 12. ALL COUNTERS, TUB DECKS & WALLS AT TUBS & SHOWERS SHALL HAVE SMOOTH, HARD, NONABSORBENT SURFACE O/ CEMENTITIOUS BACKER BOARD AND A MOISTURE RESISTANT UNDERLAYMENT TO 13. PROVIDE BACKING FOR ALL WALL AND CEILING MOUNTED CABINETS, FIXTURES, CABINETS, BRACKET, GRAB BARS, ETC. AS REQUIRED. COORDINATE WITH SUPPLIERS FOR REQUIREMENTS. 14. CALCULATIONS AND DETAILS FOR MOUNTING HANDRAILS & CONNECTION OF GUARDRAILS SHALL BE PROVIDED FOR REVIEW AND APPROVAL BY RAILING FABRICATOR PRIOR TO INSTALLATION FOR

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16. 1 LAYER 1/2" GYP. BD. ON ALL WALLS OF GARAGE. CRC R308.1. A HEIGHT OF +72" ABOVE FLOOR PER 2019 CRC R307.2 CRC TABLE R301.5 2019 CRC TABLE R302.6 (2019 CRC R311.7.5.1). 17. A DRAFT STOPS TO BE PROVIDED IN THE FLOOR/CEILING ASSEMBLIES AND ATTIC (CBC SECTIONS 718.3.3 AND 718.4.3 AND R302.12). DRAFT STOPPING SHALL DIVIDE THE CONCEALED SPACE INTO APROXIMATELY EQUAL AREAS. CBC 718.4.3 DRAFTSTOPPING SHALL BE INSTALLED IN ATTICS AND CONCEALED ROOF SPACES, SUCH THAT ANY HORIZONTAL AREA DOES NOT EXCEED 3,000 SQ. FT.

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WALL LEGEND:

8" CONCRETE

HATCH PATTERNS: DROPPED CEILING Г — — ¬ OR SOFFIT

L _ _ J

SQUARE FOOTAGE BREAKDOWN:

MAIN LEVEL FLOOR PLAN LOWER LEVEL 3 269 SQ.FT. 2 666 SQ.FT. **GROUND LEVEL**

3-CAR GARAGE COURTYARD COVERED BALCONY COVERED DECK #1 584 1 204 SQ.FT. COVERED DECK #2 COVERED MASTER PATIO 174 SQ.FT. 2 300 STORAGE #1 STORAGE #2 SQ.FT. UNCONDITIONED 579 SQ.FT. STORAGE

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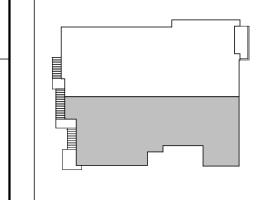
DESIGNS

KRISHNA RESIDENCE

421 TOBRURRY WAY FOLSOM CA 95630

072-2740-018-0000

KEY PLAN:



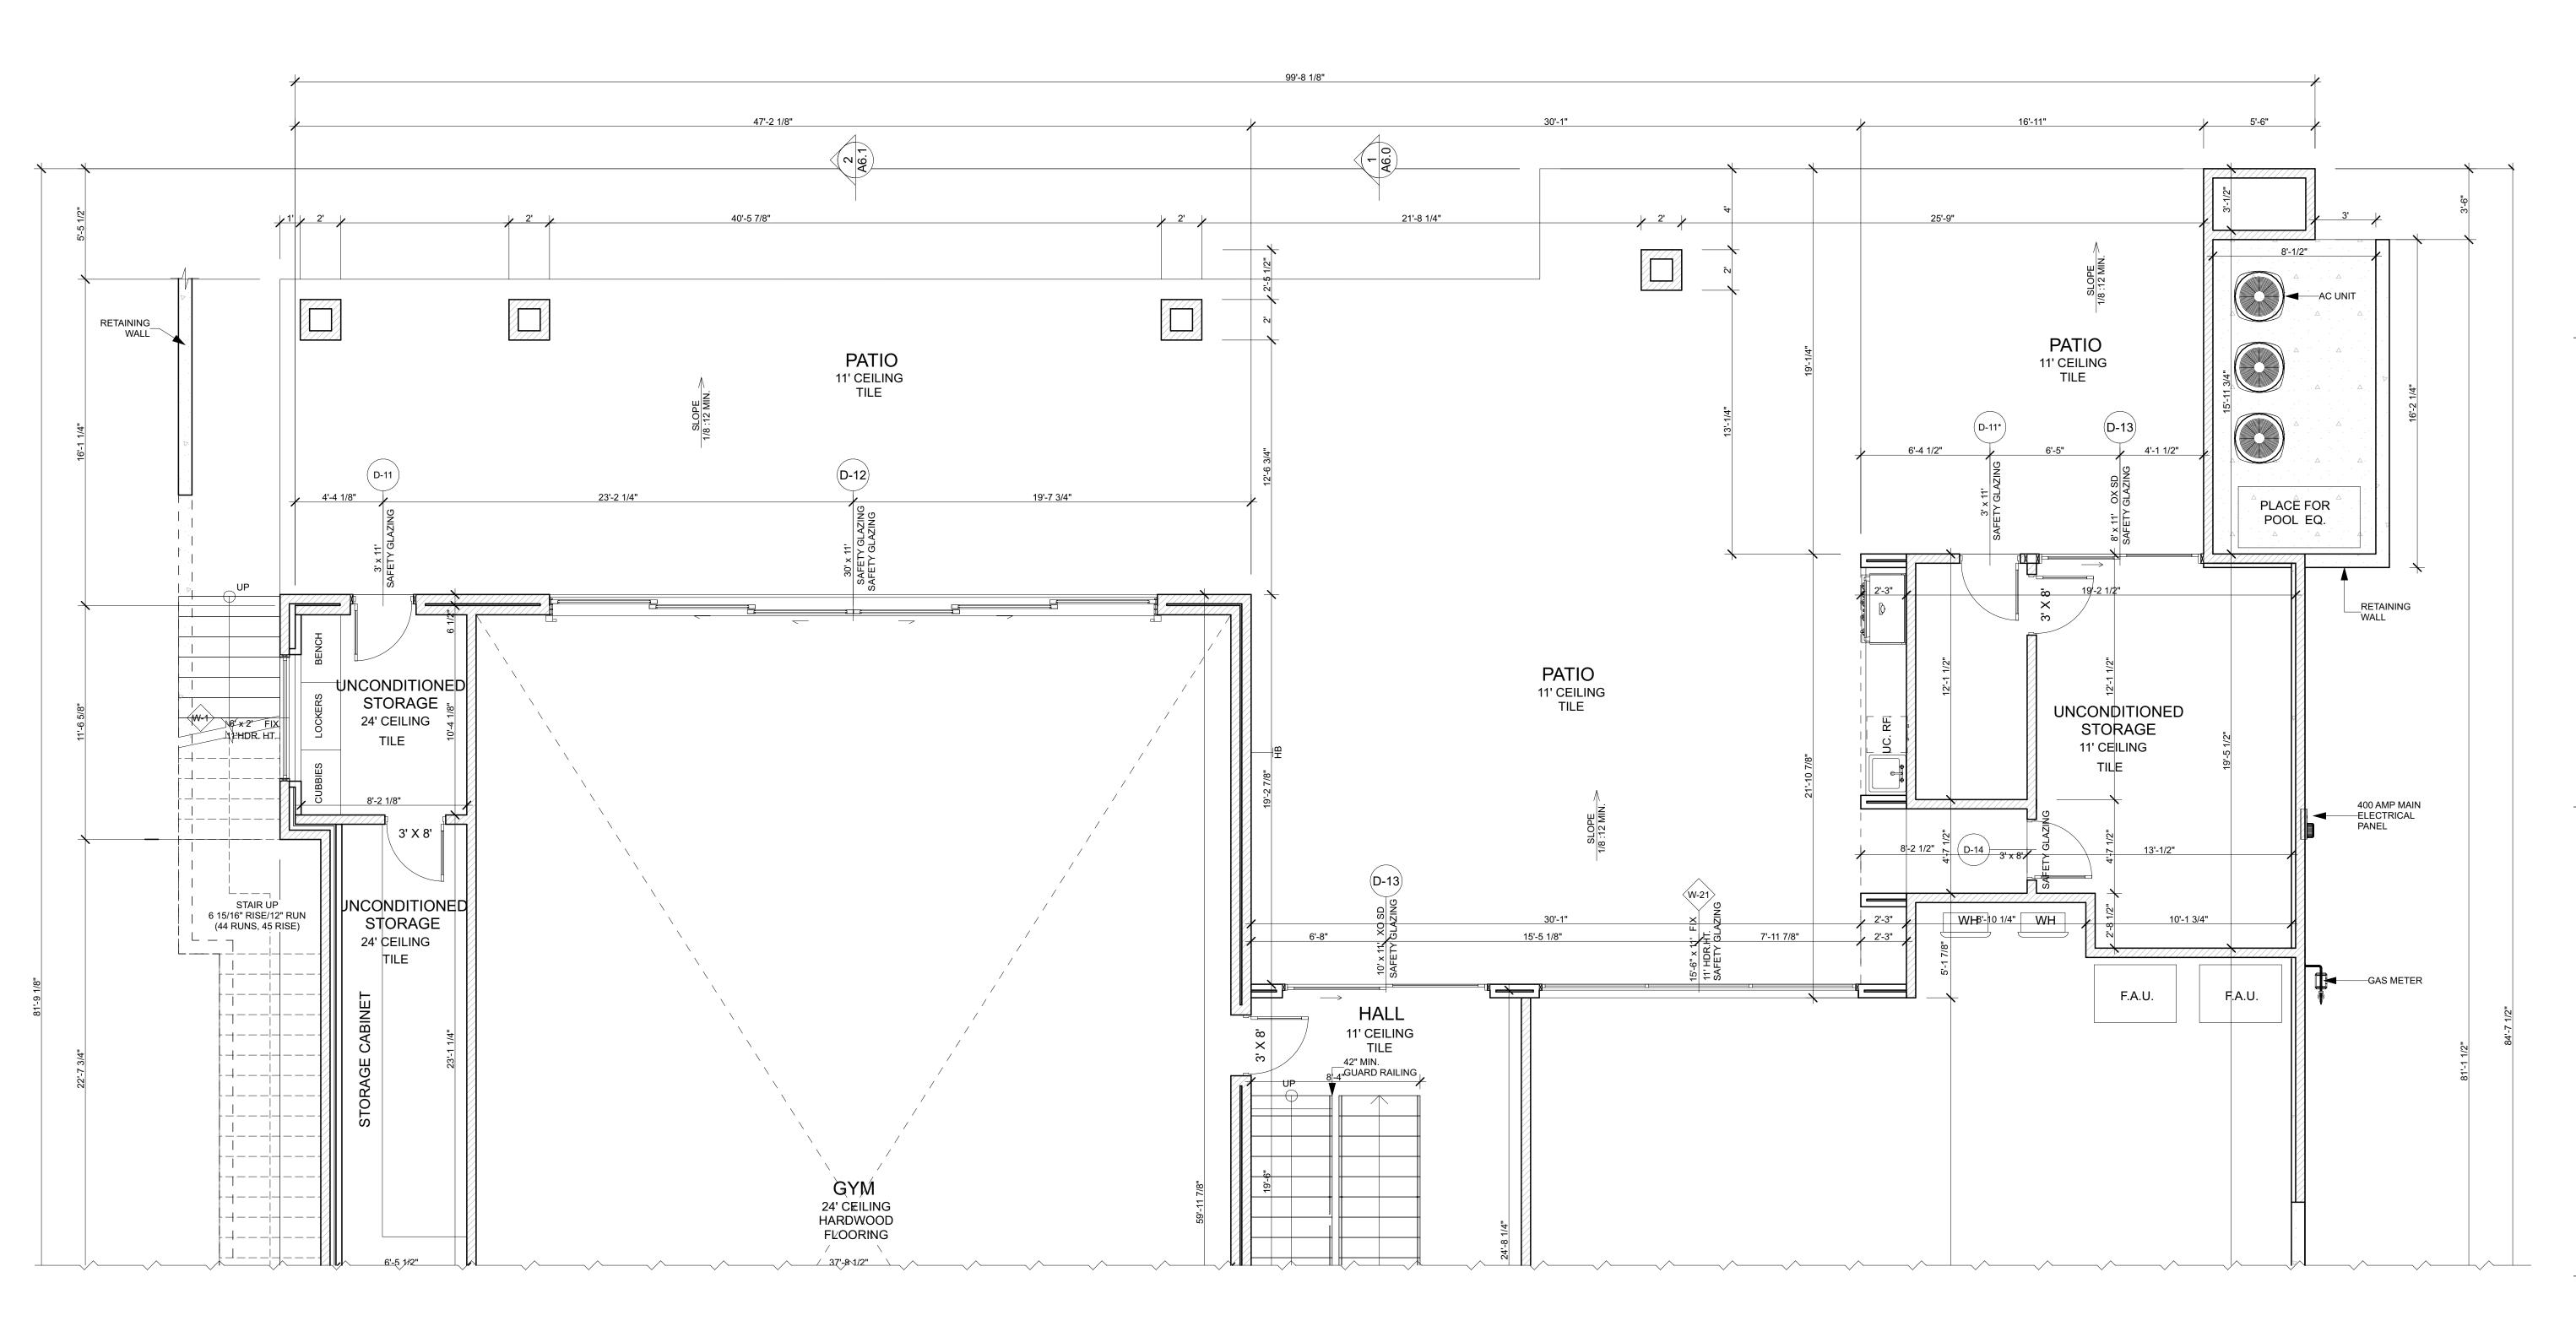
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SHEET TITLE: DETAILED GROUND LEVEL FLOOR PLAN (PART 1)



DETAILED GROUND LEVEL FLOOR PLAN (PART 2)

1/4" = 1'-0"

FLOOR PLAN NOTES:

1. ALL EXTERIOR DIMENSIONS TO FACE OF STUD, FACE OF FOUNDATION, & FACE OF STOREFRONT (U.O.N.) 2. ALL INTERIOR DIMENSIONS TO FACE OF STUD (U.O.N.) 3. ALL DIMENSIONS AT WINDOWS & DOORS ARE TO THE CENTERLINE. (U.O.N.)

4. ALL DOOR JAMBS ON HINGE SIDE SHALL BE 4" U.O.N.
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16. 1 LAYER 1/2" GYP. BD. ON ALL WALLS OF GARAGE. CRC R308.1. A HEIGHT OF +72" ABOVE FLOOR PER

2019 CRC R307.2 CRC TABLE R301.5 2019 CRC TABLE R302.6 (2019 CRC R311.7.5.1). 17. A DRAFT STOPS TO BE PROVIDED IN THE FLOOR/CEILING ASSEMBLIES AND ATTIC (CBC SECTIONS 718.3.3 AND 718.4.3 AND R302.12). DRAFT STOPPING SHALL DIVIDE THE CONCEALED SPACE INTO APROXIMATELY EQUAL AREAS. ĆBC 718.4.3 DRAFTSTOPPING SHALL BE INSTALLED IN ATTICS AND CONCEALED ROOF SPACES, SUCH THAT ANY HORIZONTAL AREA DOES NOT EXCEED 3,000 SQ. FT. CONTRACTOR TO VERIFY IN FIELD. 18. EXTERIOR DOORS: RECESS CONCRETE (WHERE OCCURS) AT DOOR THRESHOLDS TO MINIMIZE THRESHOLD HEIGHT - COORDINATE WITH FLOORING (WOOD, CARPET, OR EXPOSED CONCRETE, ETC). CONSULT MANUFACTURER FOR ANY THRESHOLD REQUIEMENTS FOR CONCRETE SLAB APPLICATIONS.

THRESHOLD MUST COMPLY WITH MANUFACTURER'S WEATHER-PROOFING REQUIREMENT

19. 2" RECESS. RECESS FOUNDATION AT ALL RECESSED DOORS.

WALL LEGEND:

8" CONCRETE

HATCH PATTERNS:

DROPPED CEILING Г — — ¬ OR SOFFIT L _ _ J

SQUARE FOOTAGE BREAKDOWN:

MAIN LEVEL FLOOR PLAN LOWER LEVEL 3 269 SQ.FT. 2 666 **GROUND LEVEL** SQ.FT.

COURTYARD COVERED BALCONY COVERED DECK #1 584 1 204 SQ.FT. COVERED DECK #2 COVERED MASTER PATIO 174 SQ.FT. 2 300 STORAGE #1 STORAGE #2 SQ.FT. UNCONDITIONED 579 SQ.FT. STORAGE

3-CAR GARAGE

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DESIGNS

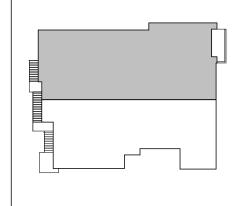
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KRISHNA RESIDENCE

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KEY PLAN:



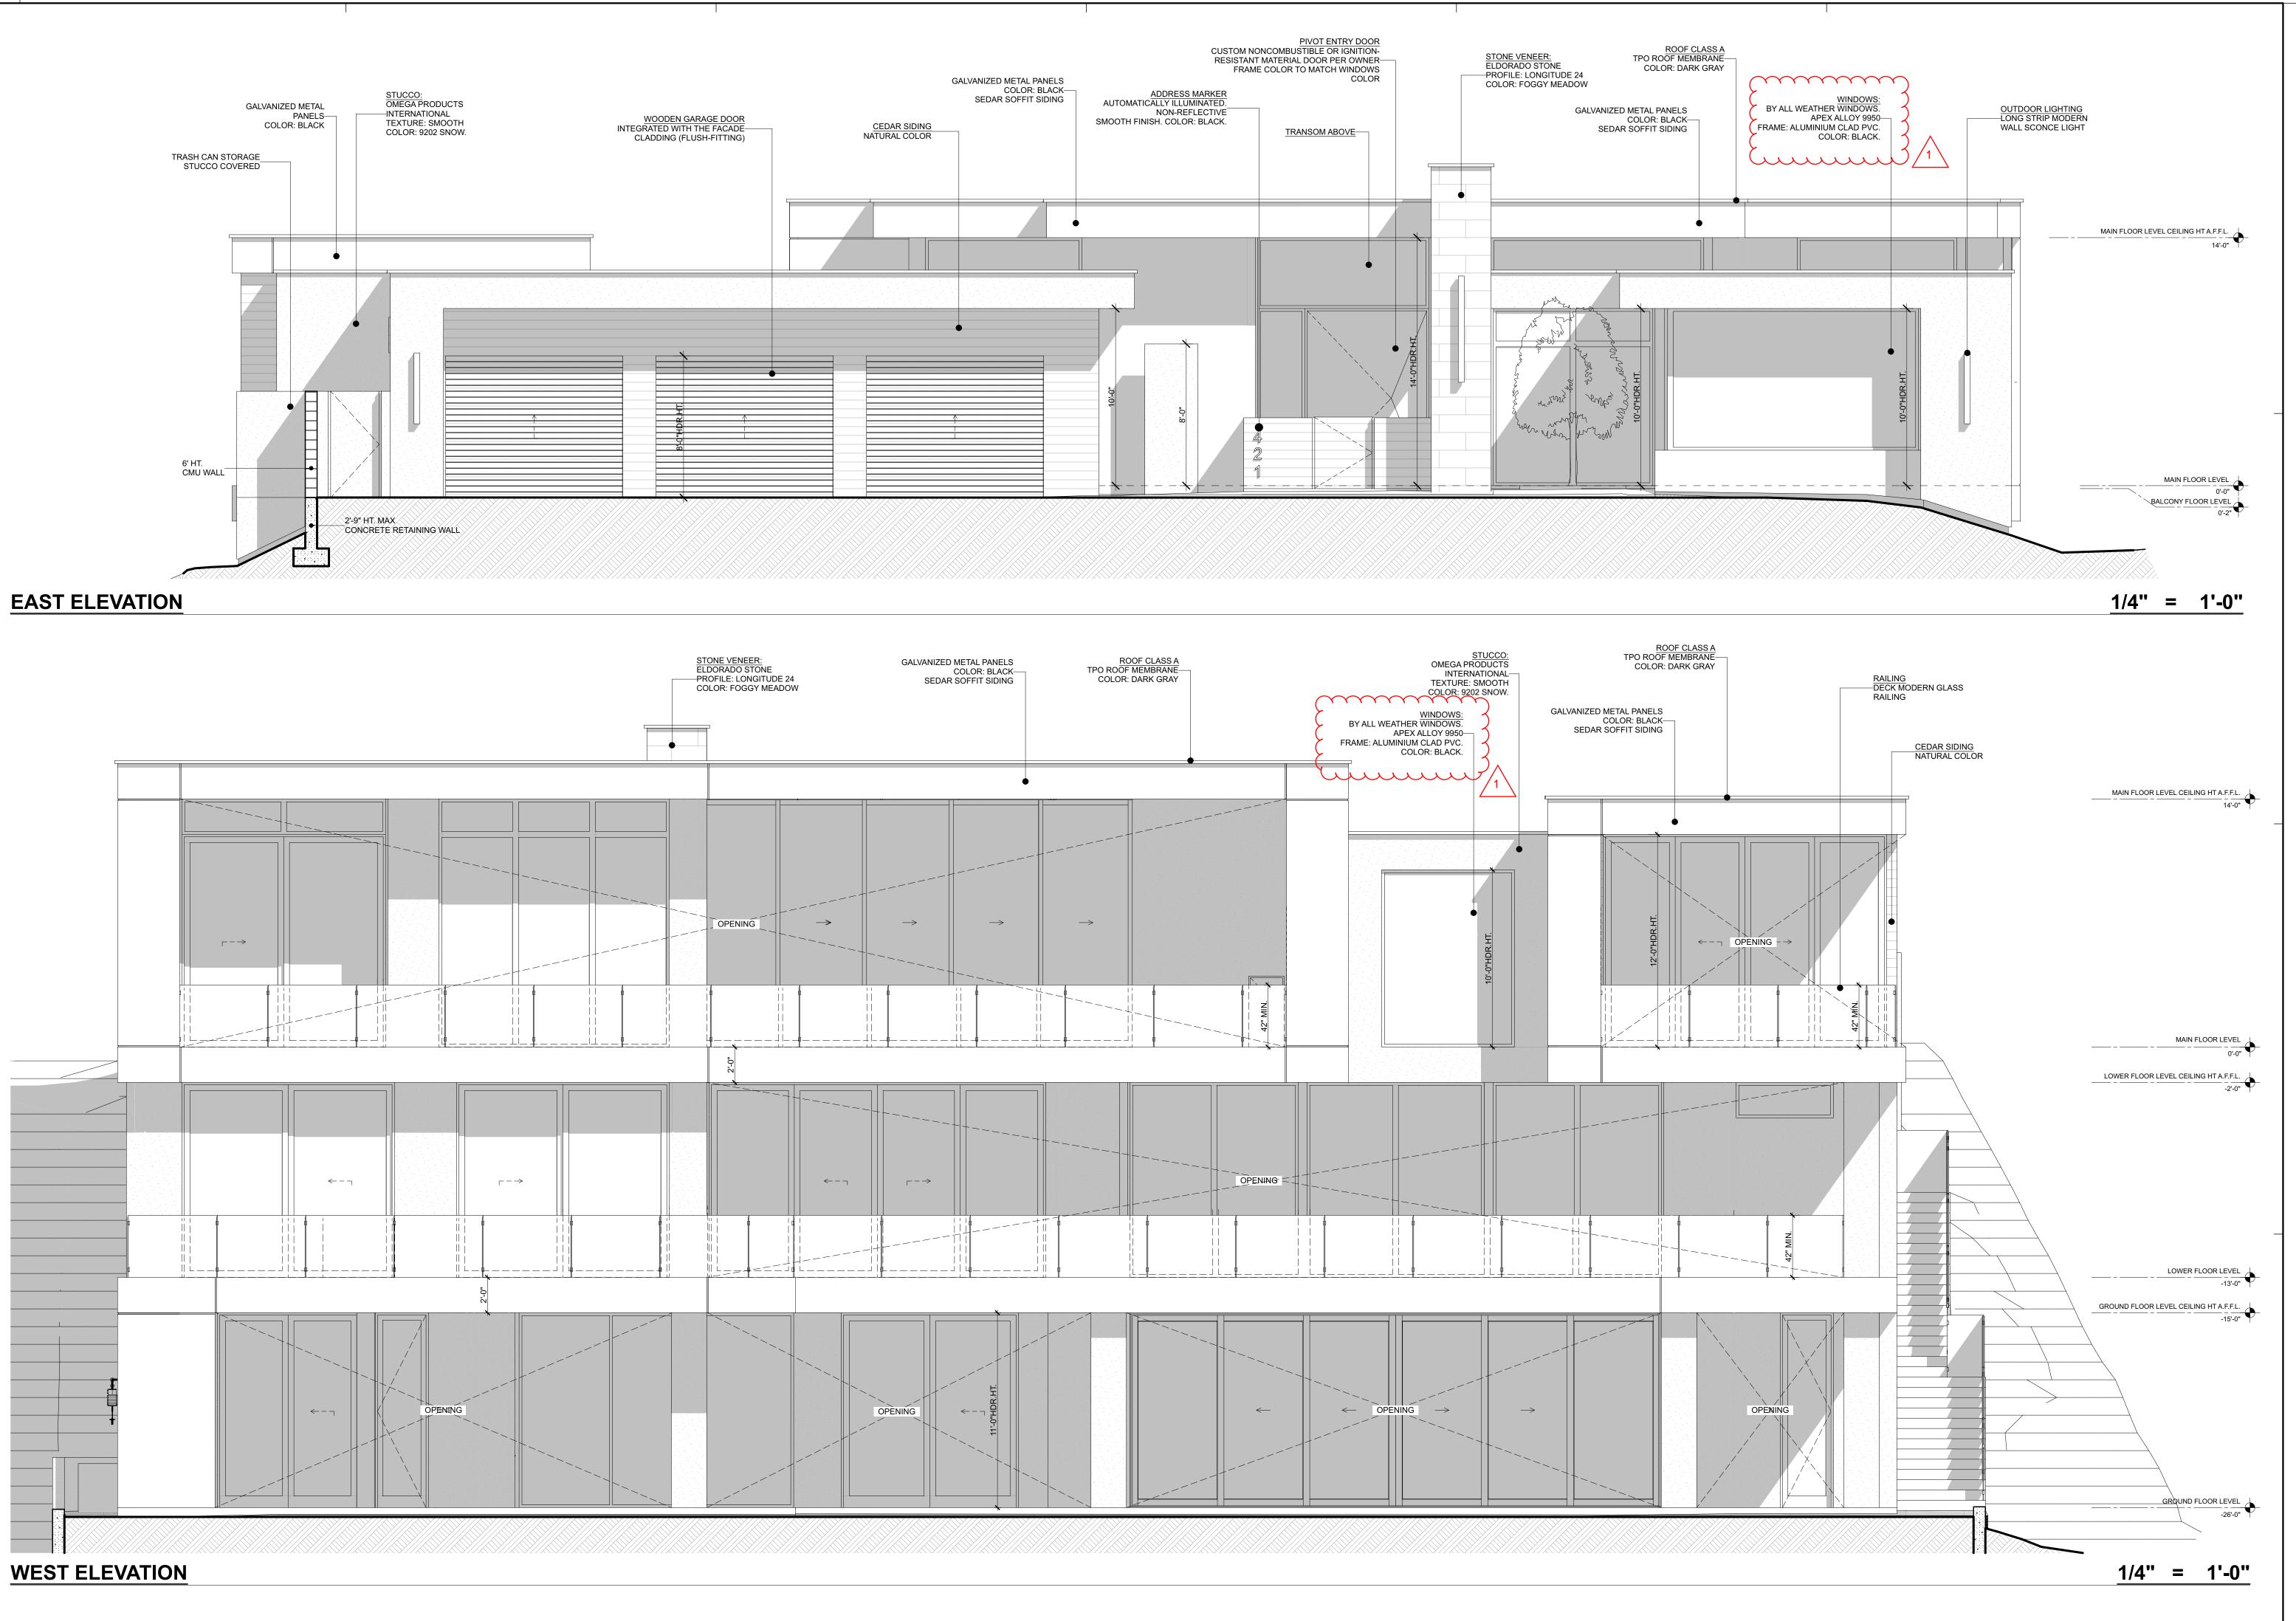
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DETAILED GROUND LEVEL

FLOOR PLAN (PART 2)





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Jan Jan

KRISHNA RESIDENCE

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MARK DATE DESCRIPTION

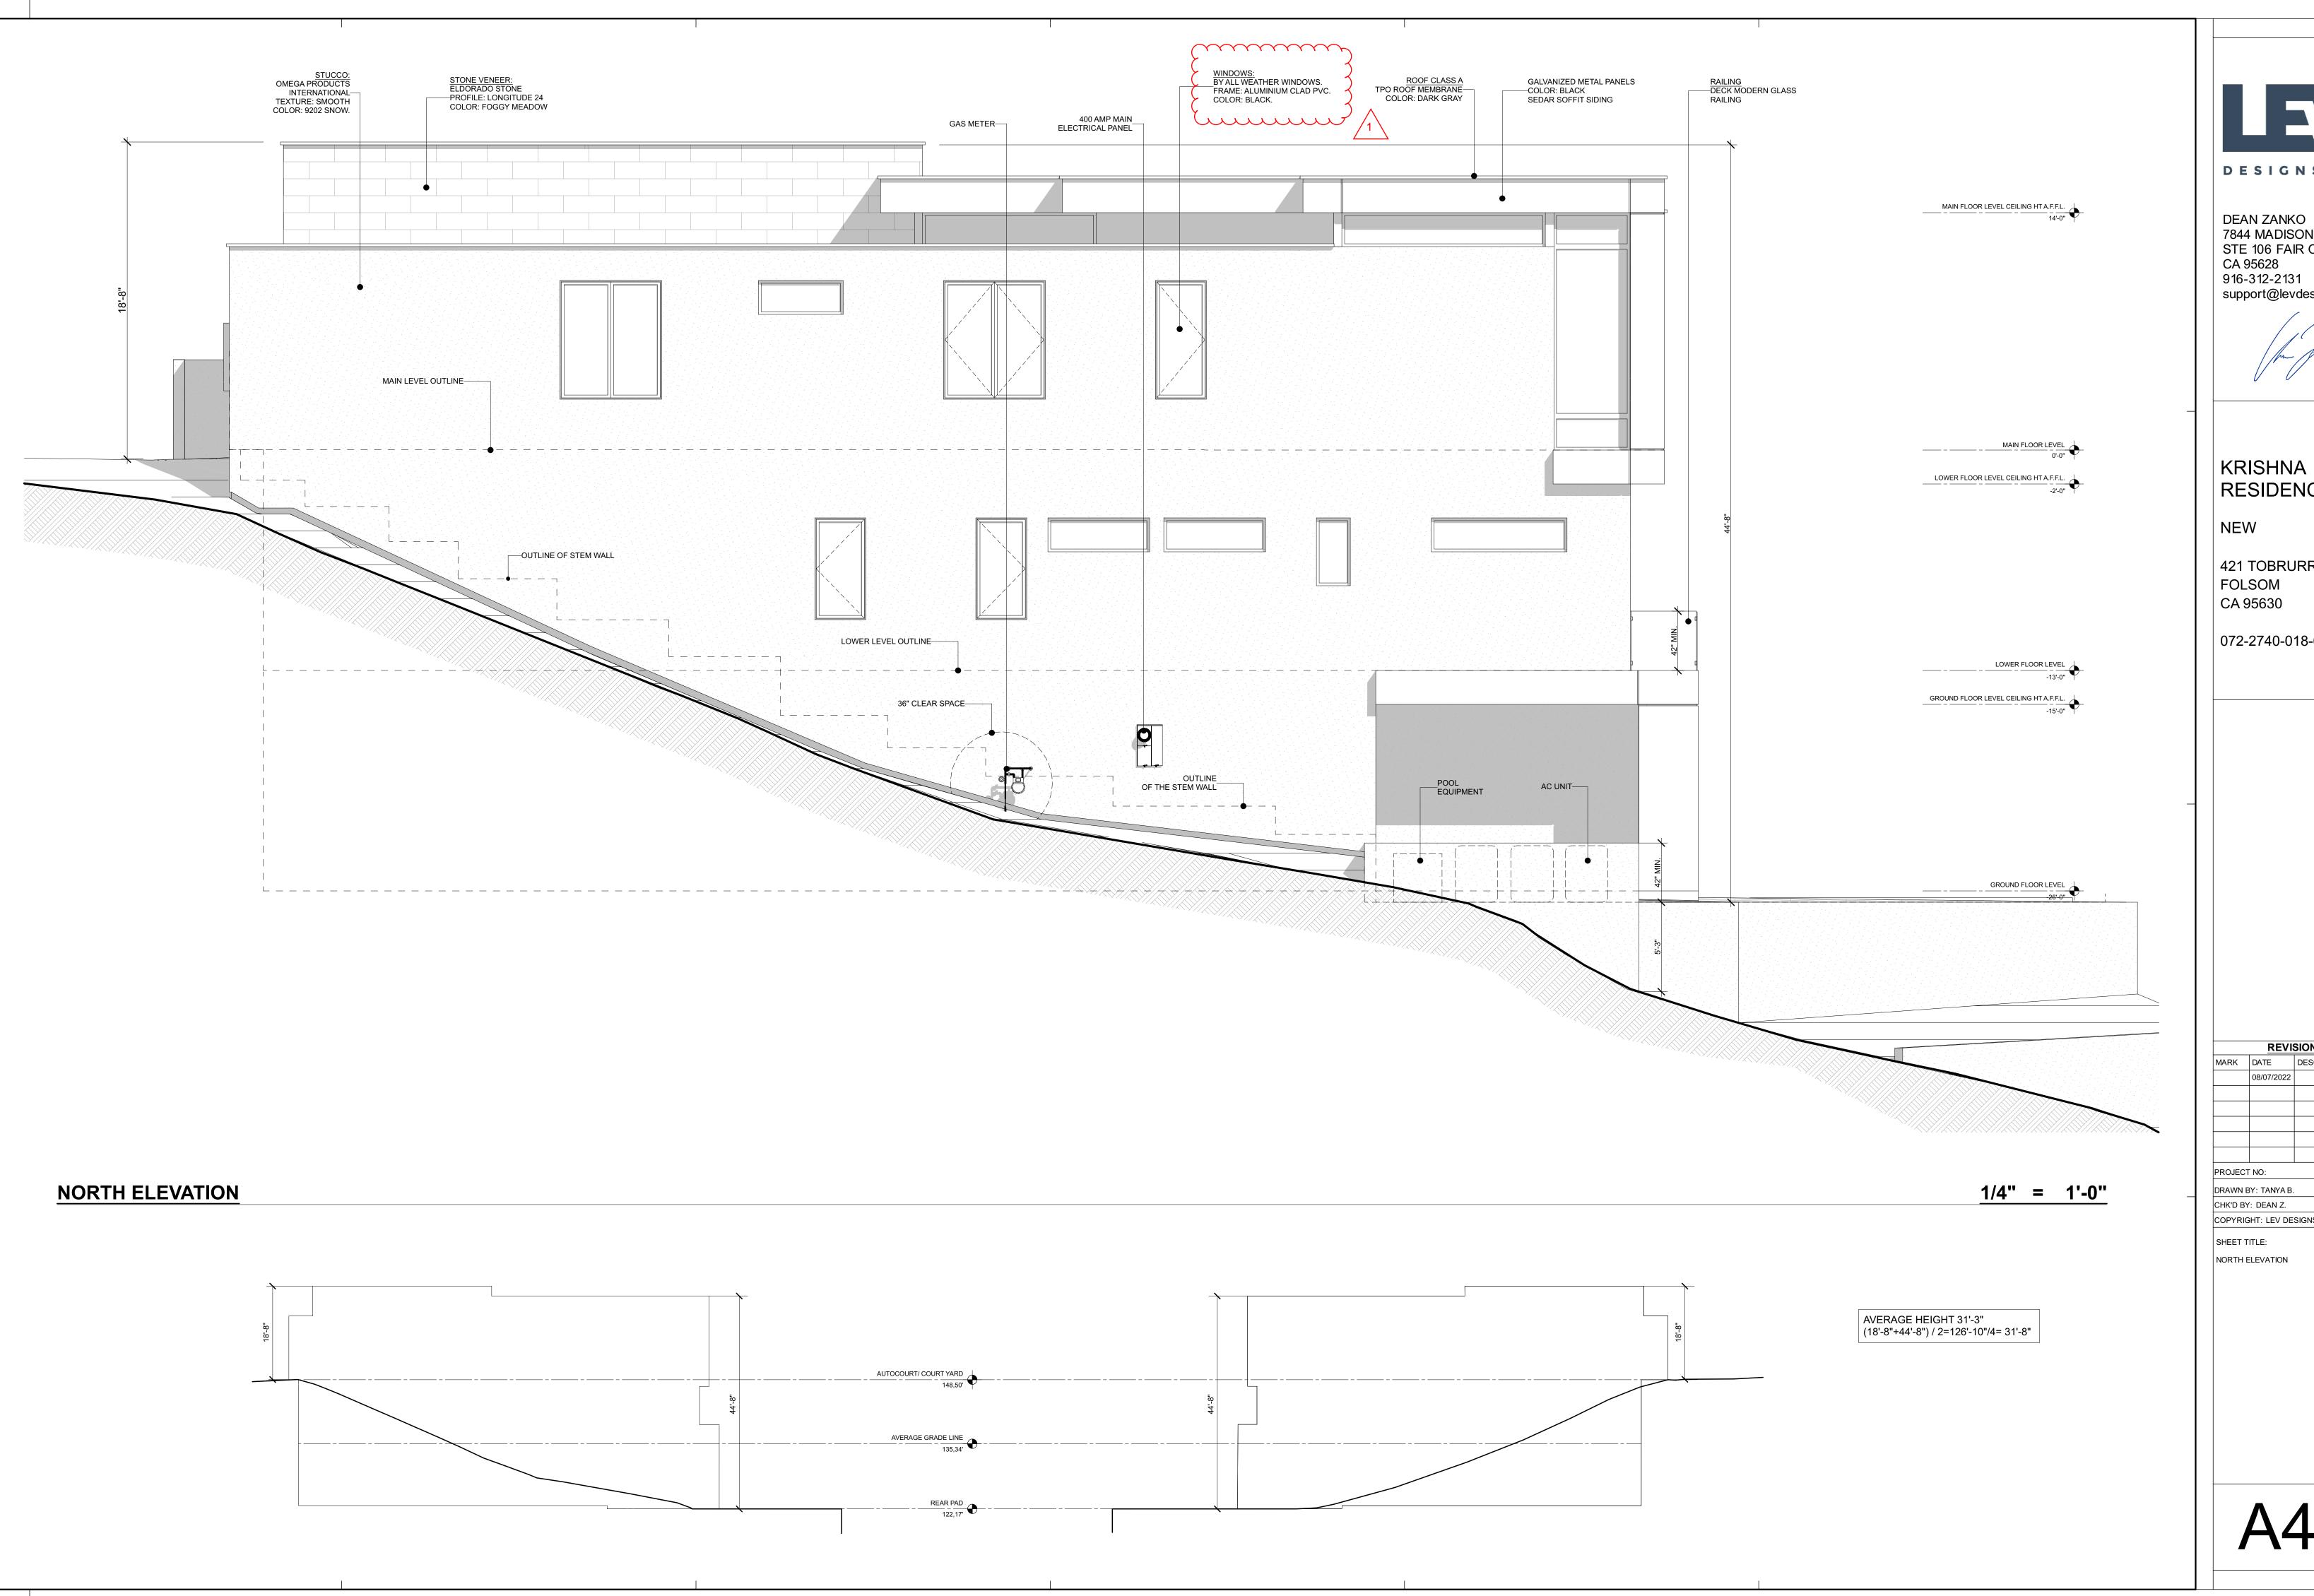
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SHEET TITLE:

EAST/WEST ELEVATIONS

PROJECT NO:

A4.0





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KRISHNA RESIDENCE

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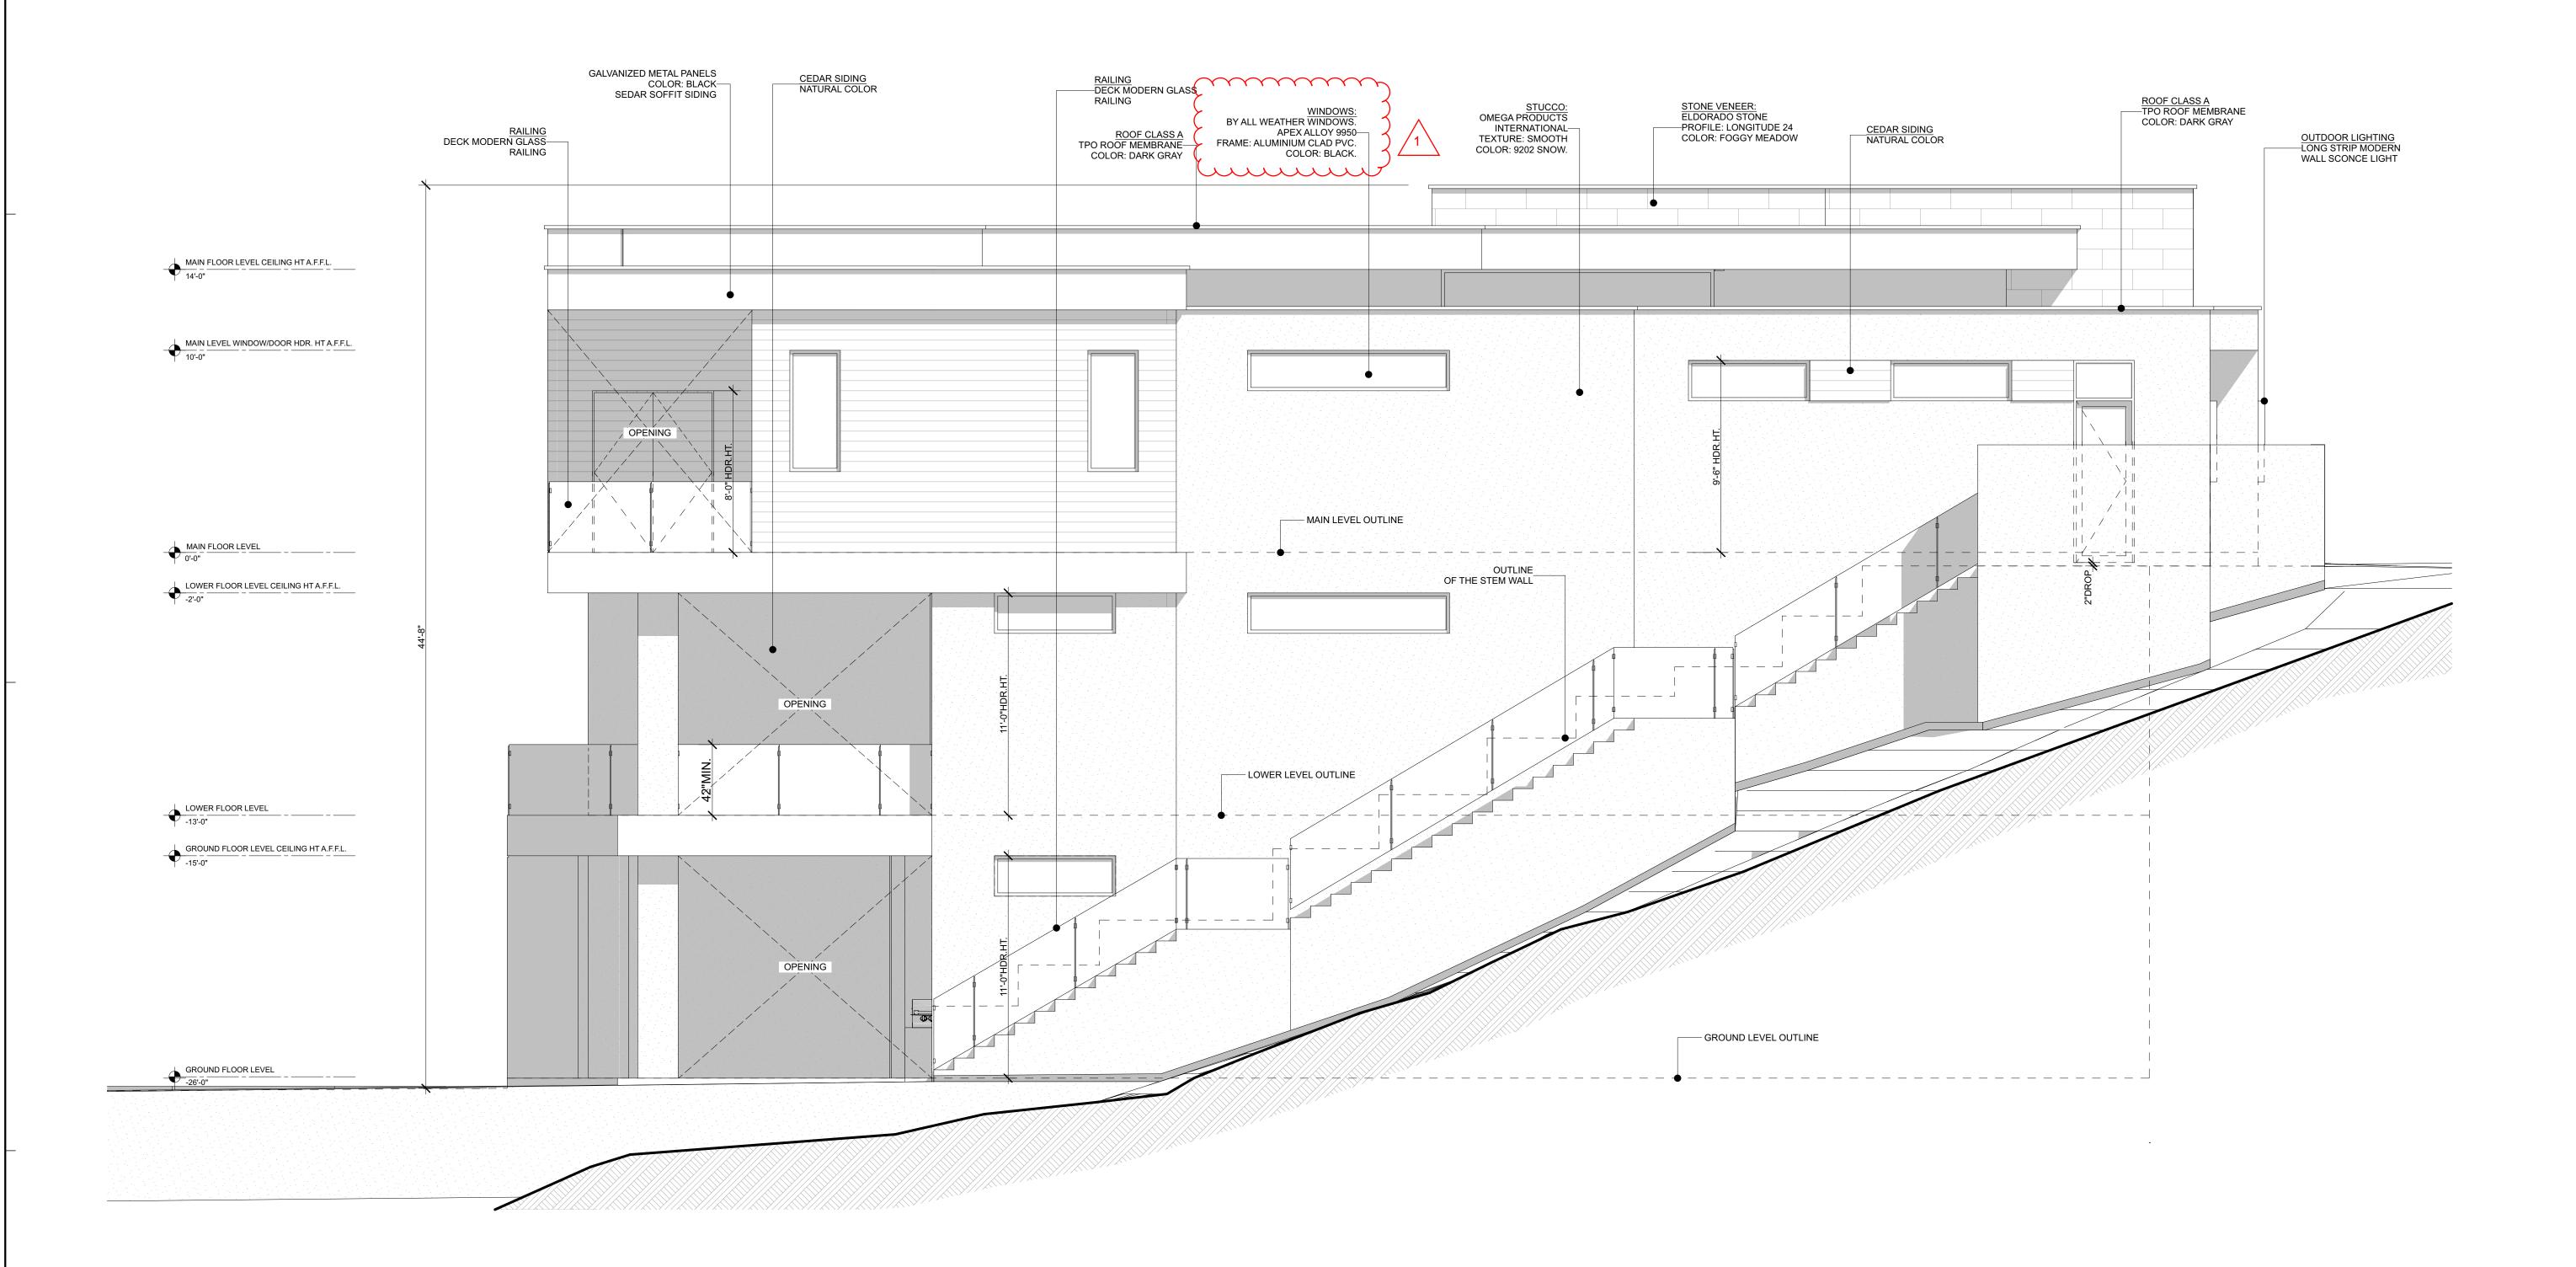
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SHEET TITLE: NORTH ELEVATION



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Jan Jan

KRISHNA RESIDENCE

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REVISIONS

MARK DATE DESCRIPTION

08/07/2022

PROJECT NO:

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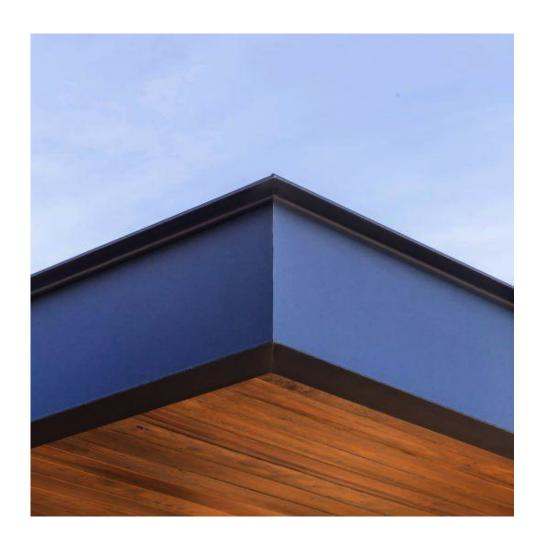
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SHEET TITLE: SOUTH ELEVATION

SOUTH ELEVATION

1/4" = 1'-0"



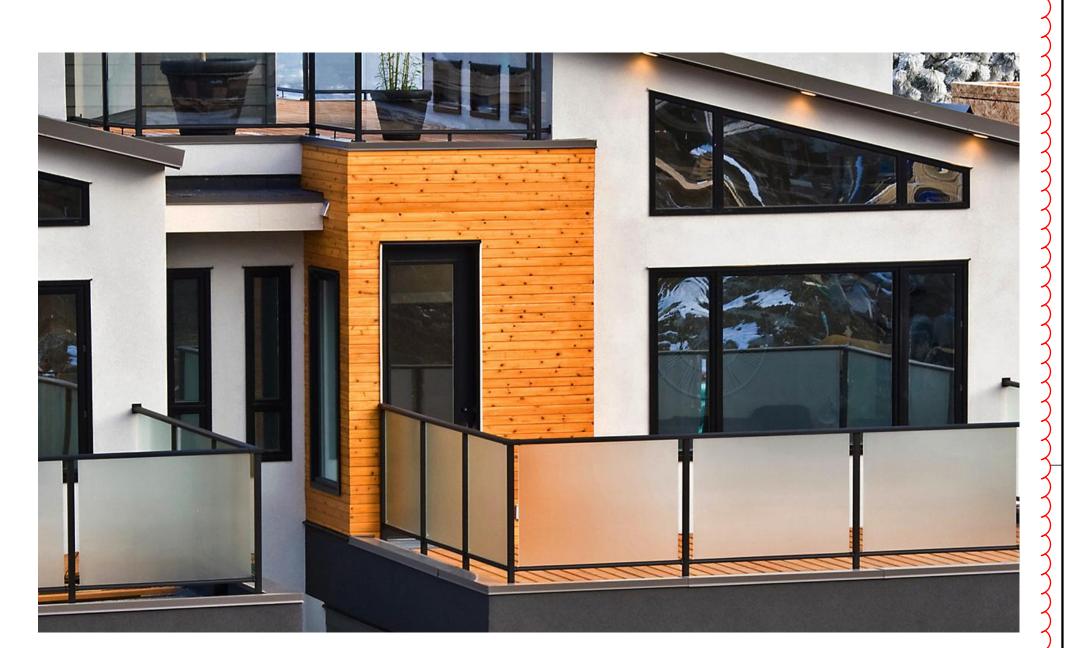
FLAT ROOF BLACK METAL CLADDING & **CEDAR SOFFIT SIDING**



FLAT ROOF TPO MEMBRANE. **COLOR: DARK GRAY**



CEDAR SIDING NATURAL COLOR



WINDOWS: BY ALL WEATHER WINDOW. APEX ALLOY 9950 FRAME: ALUMINUM CLAD PVC.

COLOR: BLACK

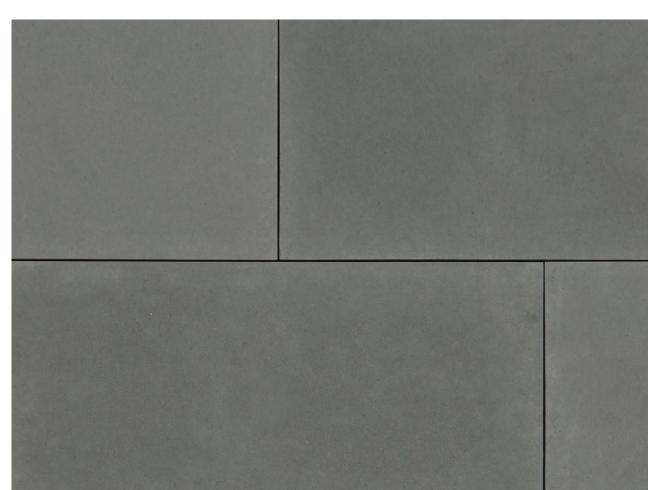


DECK MODERN GLASS RAILING



OUTDOOR LONG STRIP MODERN WALL SCONCE LIGHT





STONE VENEER. **ELDORADO STONE.** LONGITUDE24 **COLOR: FOGGY MEADOW**



METAL PANEL. COLOR: BLACK

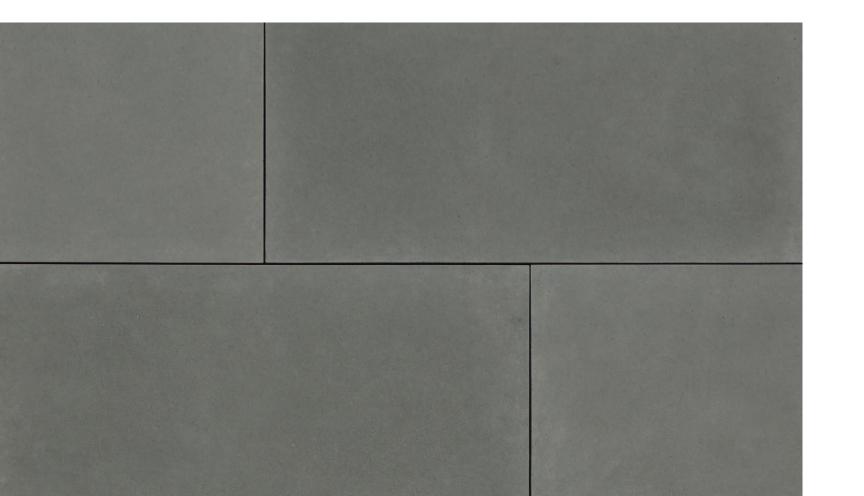
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WOODEN GARAGE DOOR

CLADDING (FLUSH-FITTING)

INTEGRATED WITH THE FACADE



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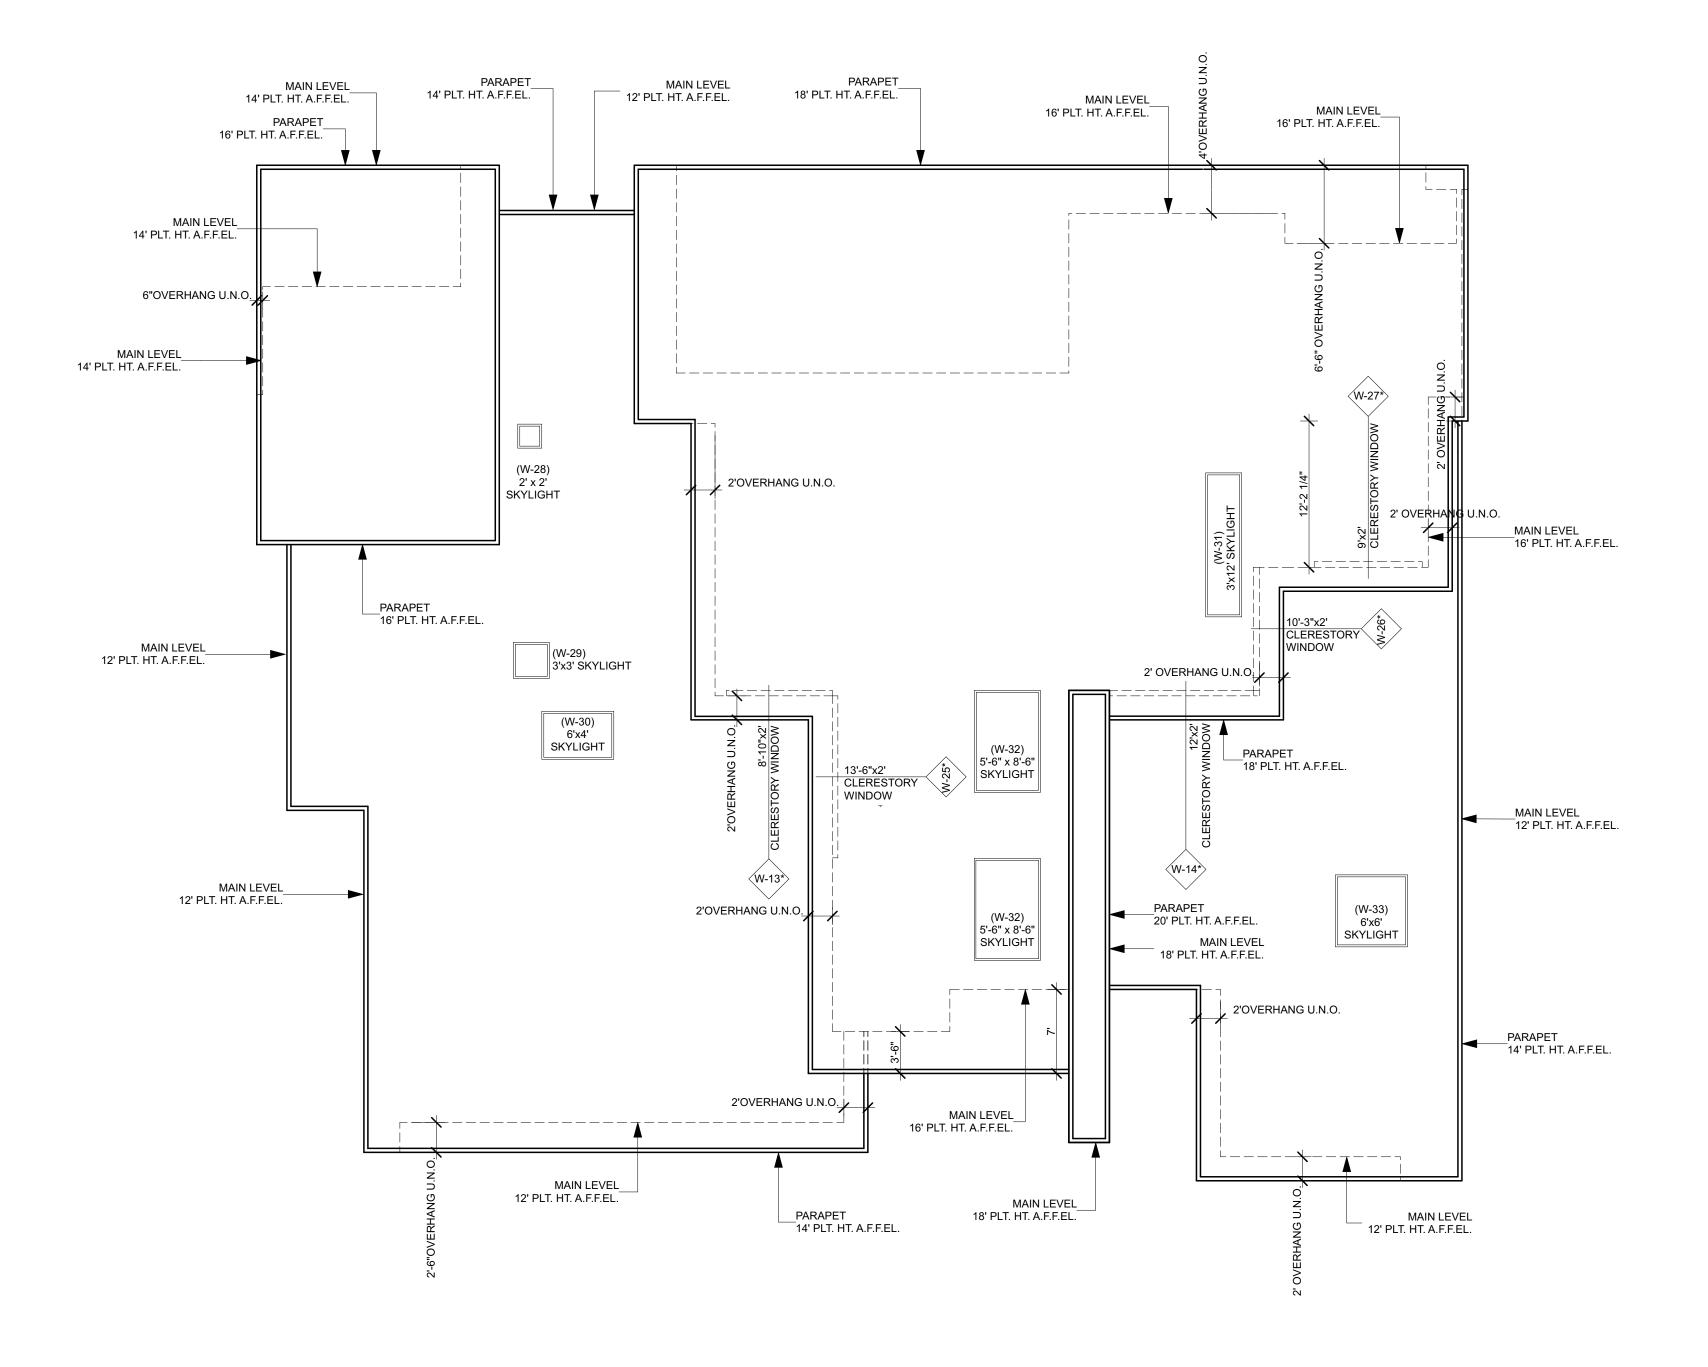
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072-2740-018-0000

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REVISIONS



GENERAL ROOF NOTES:

ROOFING CONTRACTOR SHALL PROVIDE A CERTIFICATE STATING THAT THE ROOFING HAS BEEN APPLIED PER MANUFACTURES RECOMENDATIONS.
 ALL ROOF FLASHING TO BE 26 GAUGE GALVANIZED IRON, COPPER OR ALUMINUM AND PAINTED TO MATCH ROOFING COLOR. UNO

3. PROVIDE ALUMINUM SEAMLESS GUTTER AND DOWNSPOUTS AS NECESSARY (W/ SPLASHBLOCKS AS REQ.)4. CONTRACTOR TO VERIFY TRUSS SIZES, ROOF SLOPE AND QUANTITY PRIOR TO FABRICATION.

ROOF NOTE:

NO ATTIC VENTILATION REQUIRED.
THE DESIGN SLOPE SHALL BE 1/4" PER FT. (2,08%)



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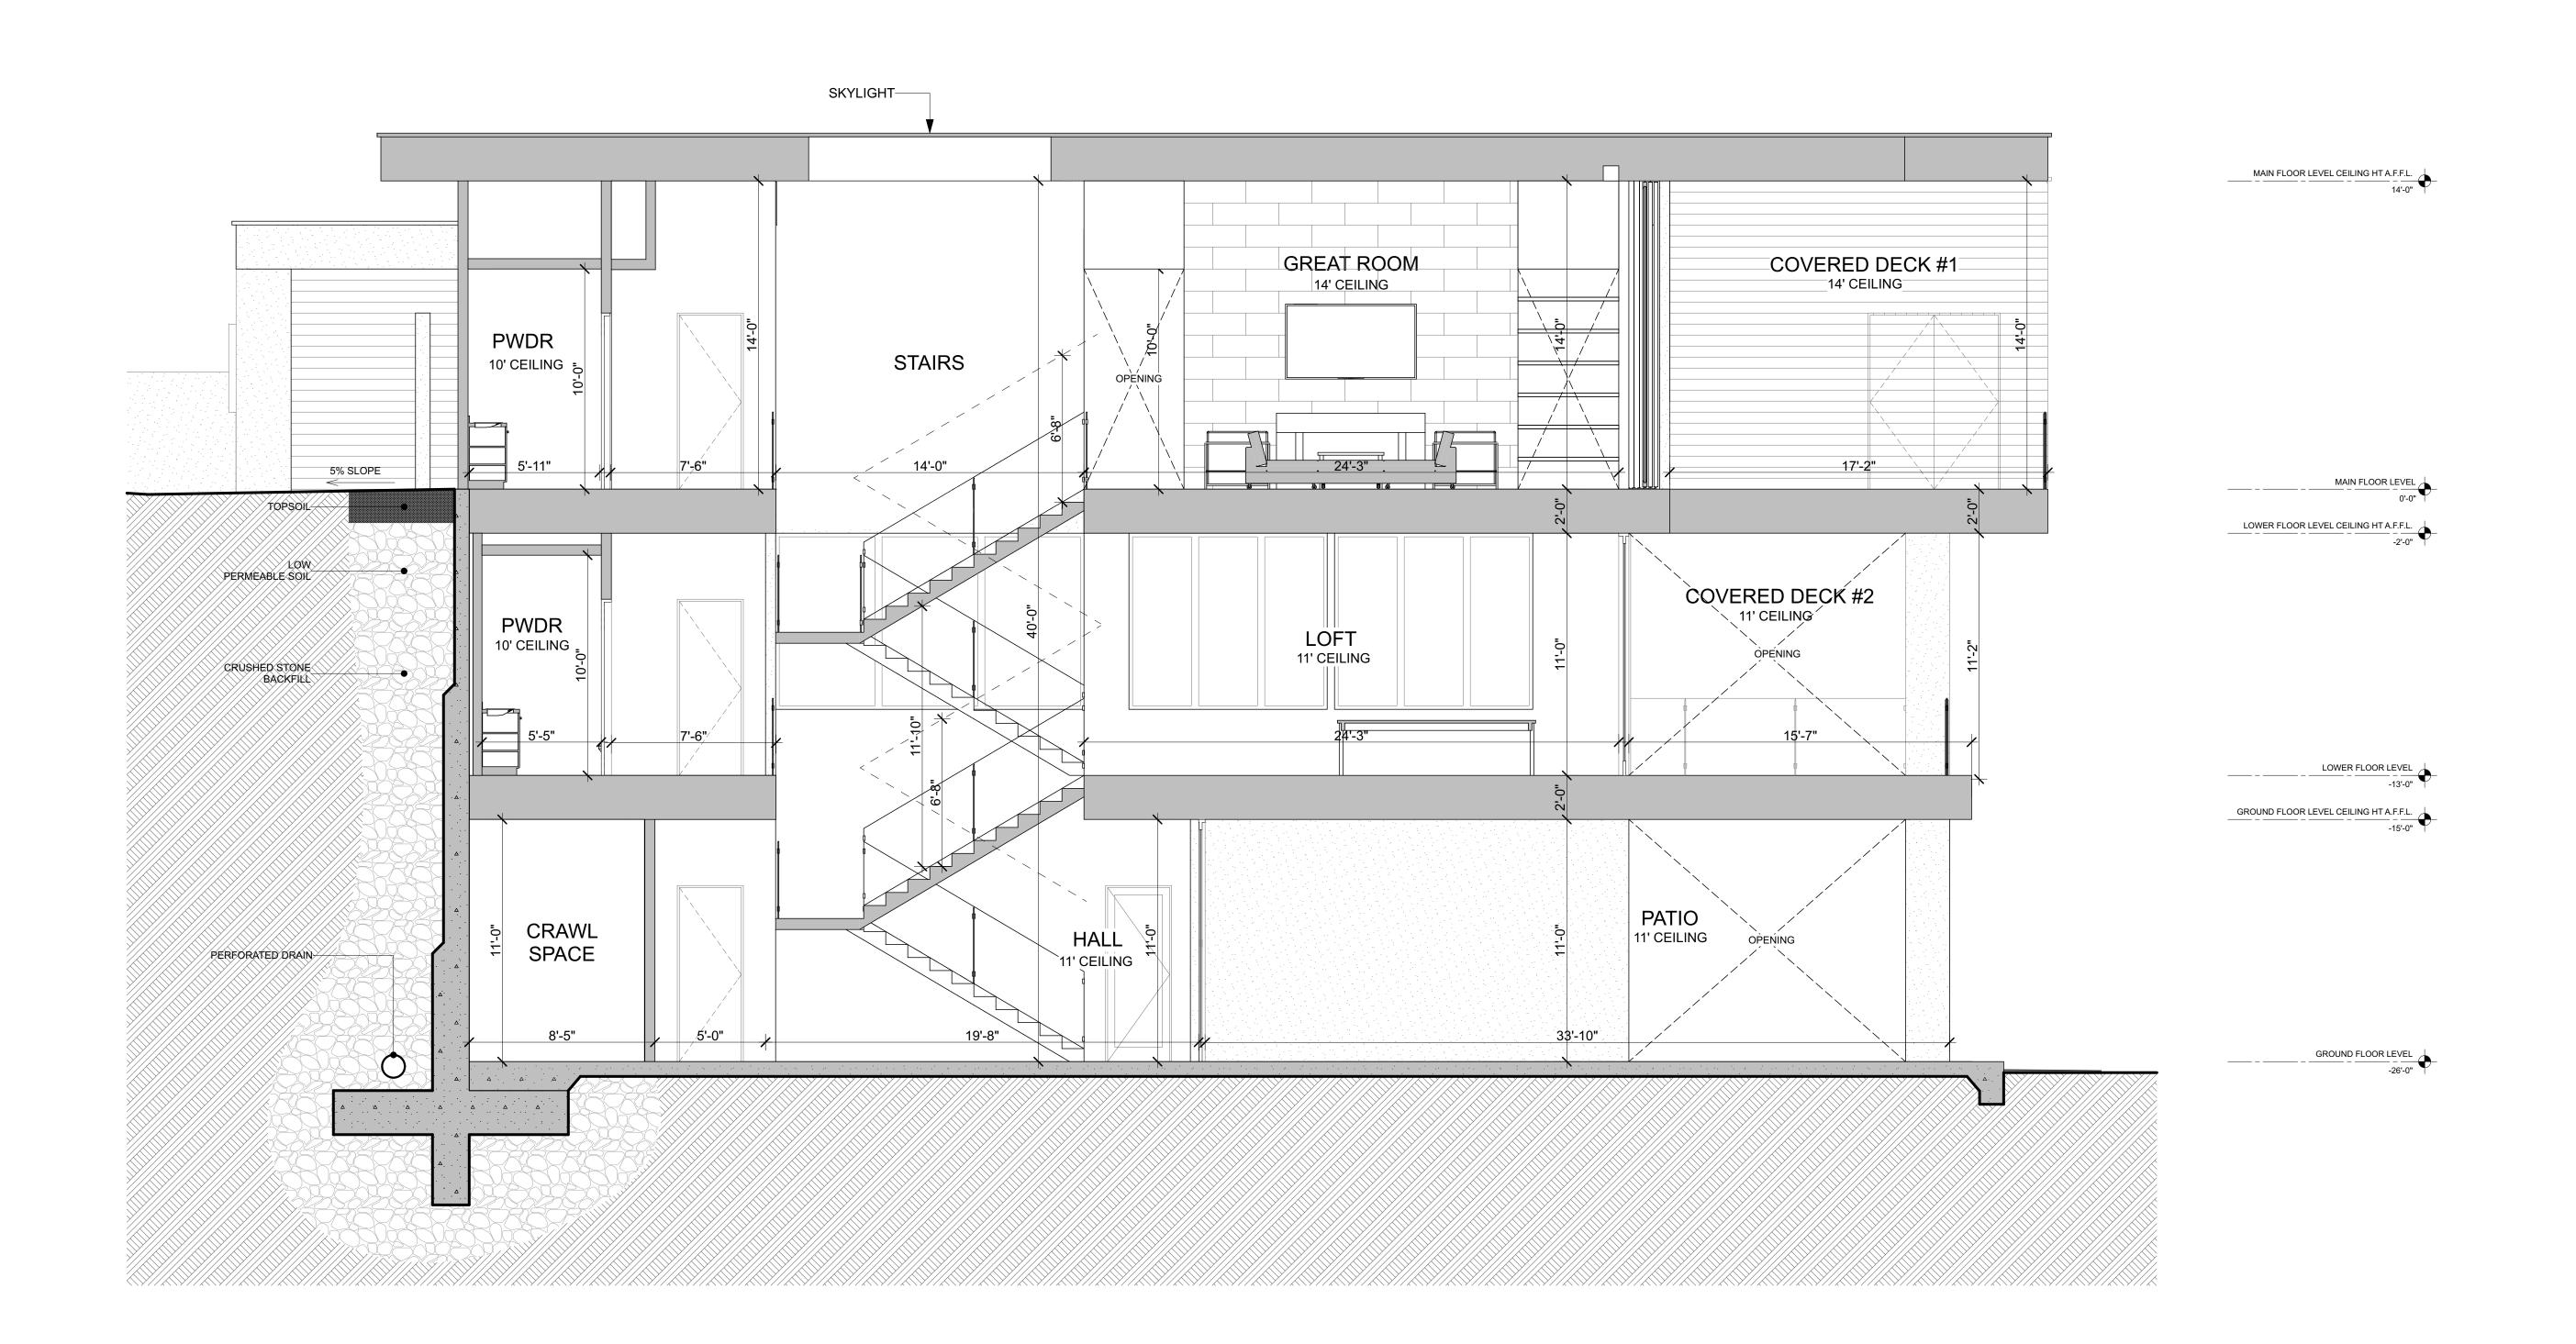
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SHEET TITLE:

<u>1/8" = 1'-0"</u>

ROOF PLAN

A5.0



SECTION 1

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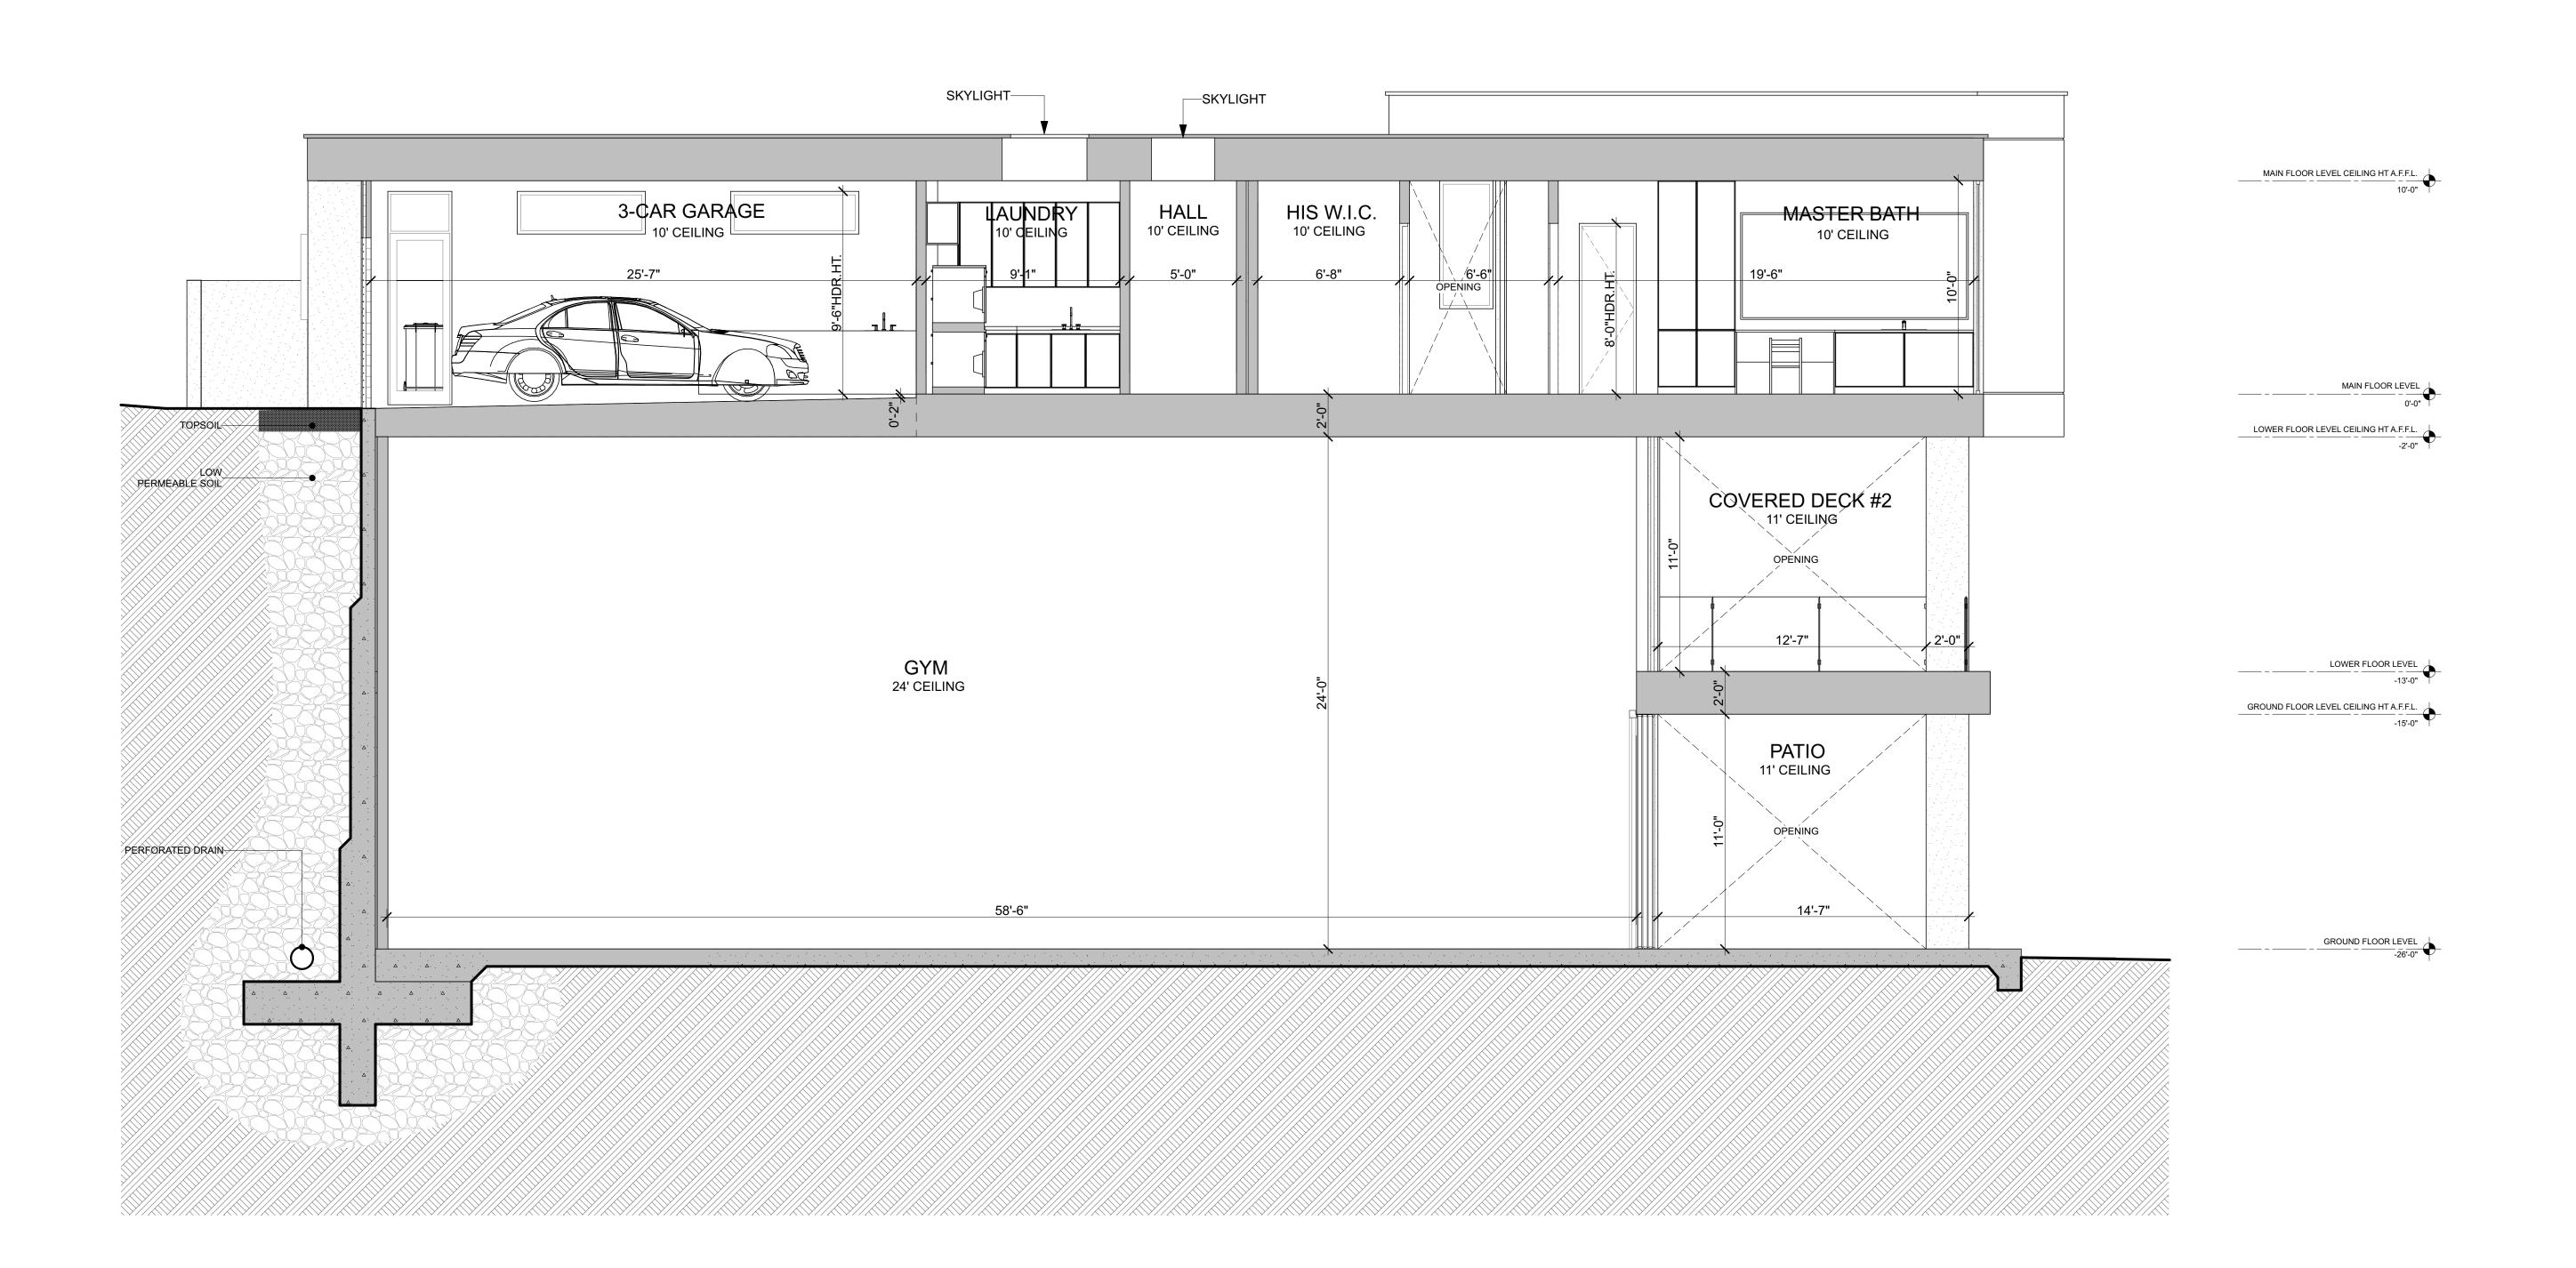
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SHEET TITLE
SECTION 1

<u>1/4" = 1'-0"</u>

A6.0



SECTION 2



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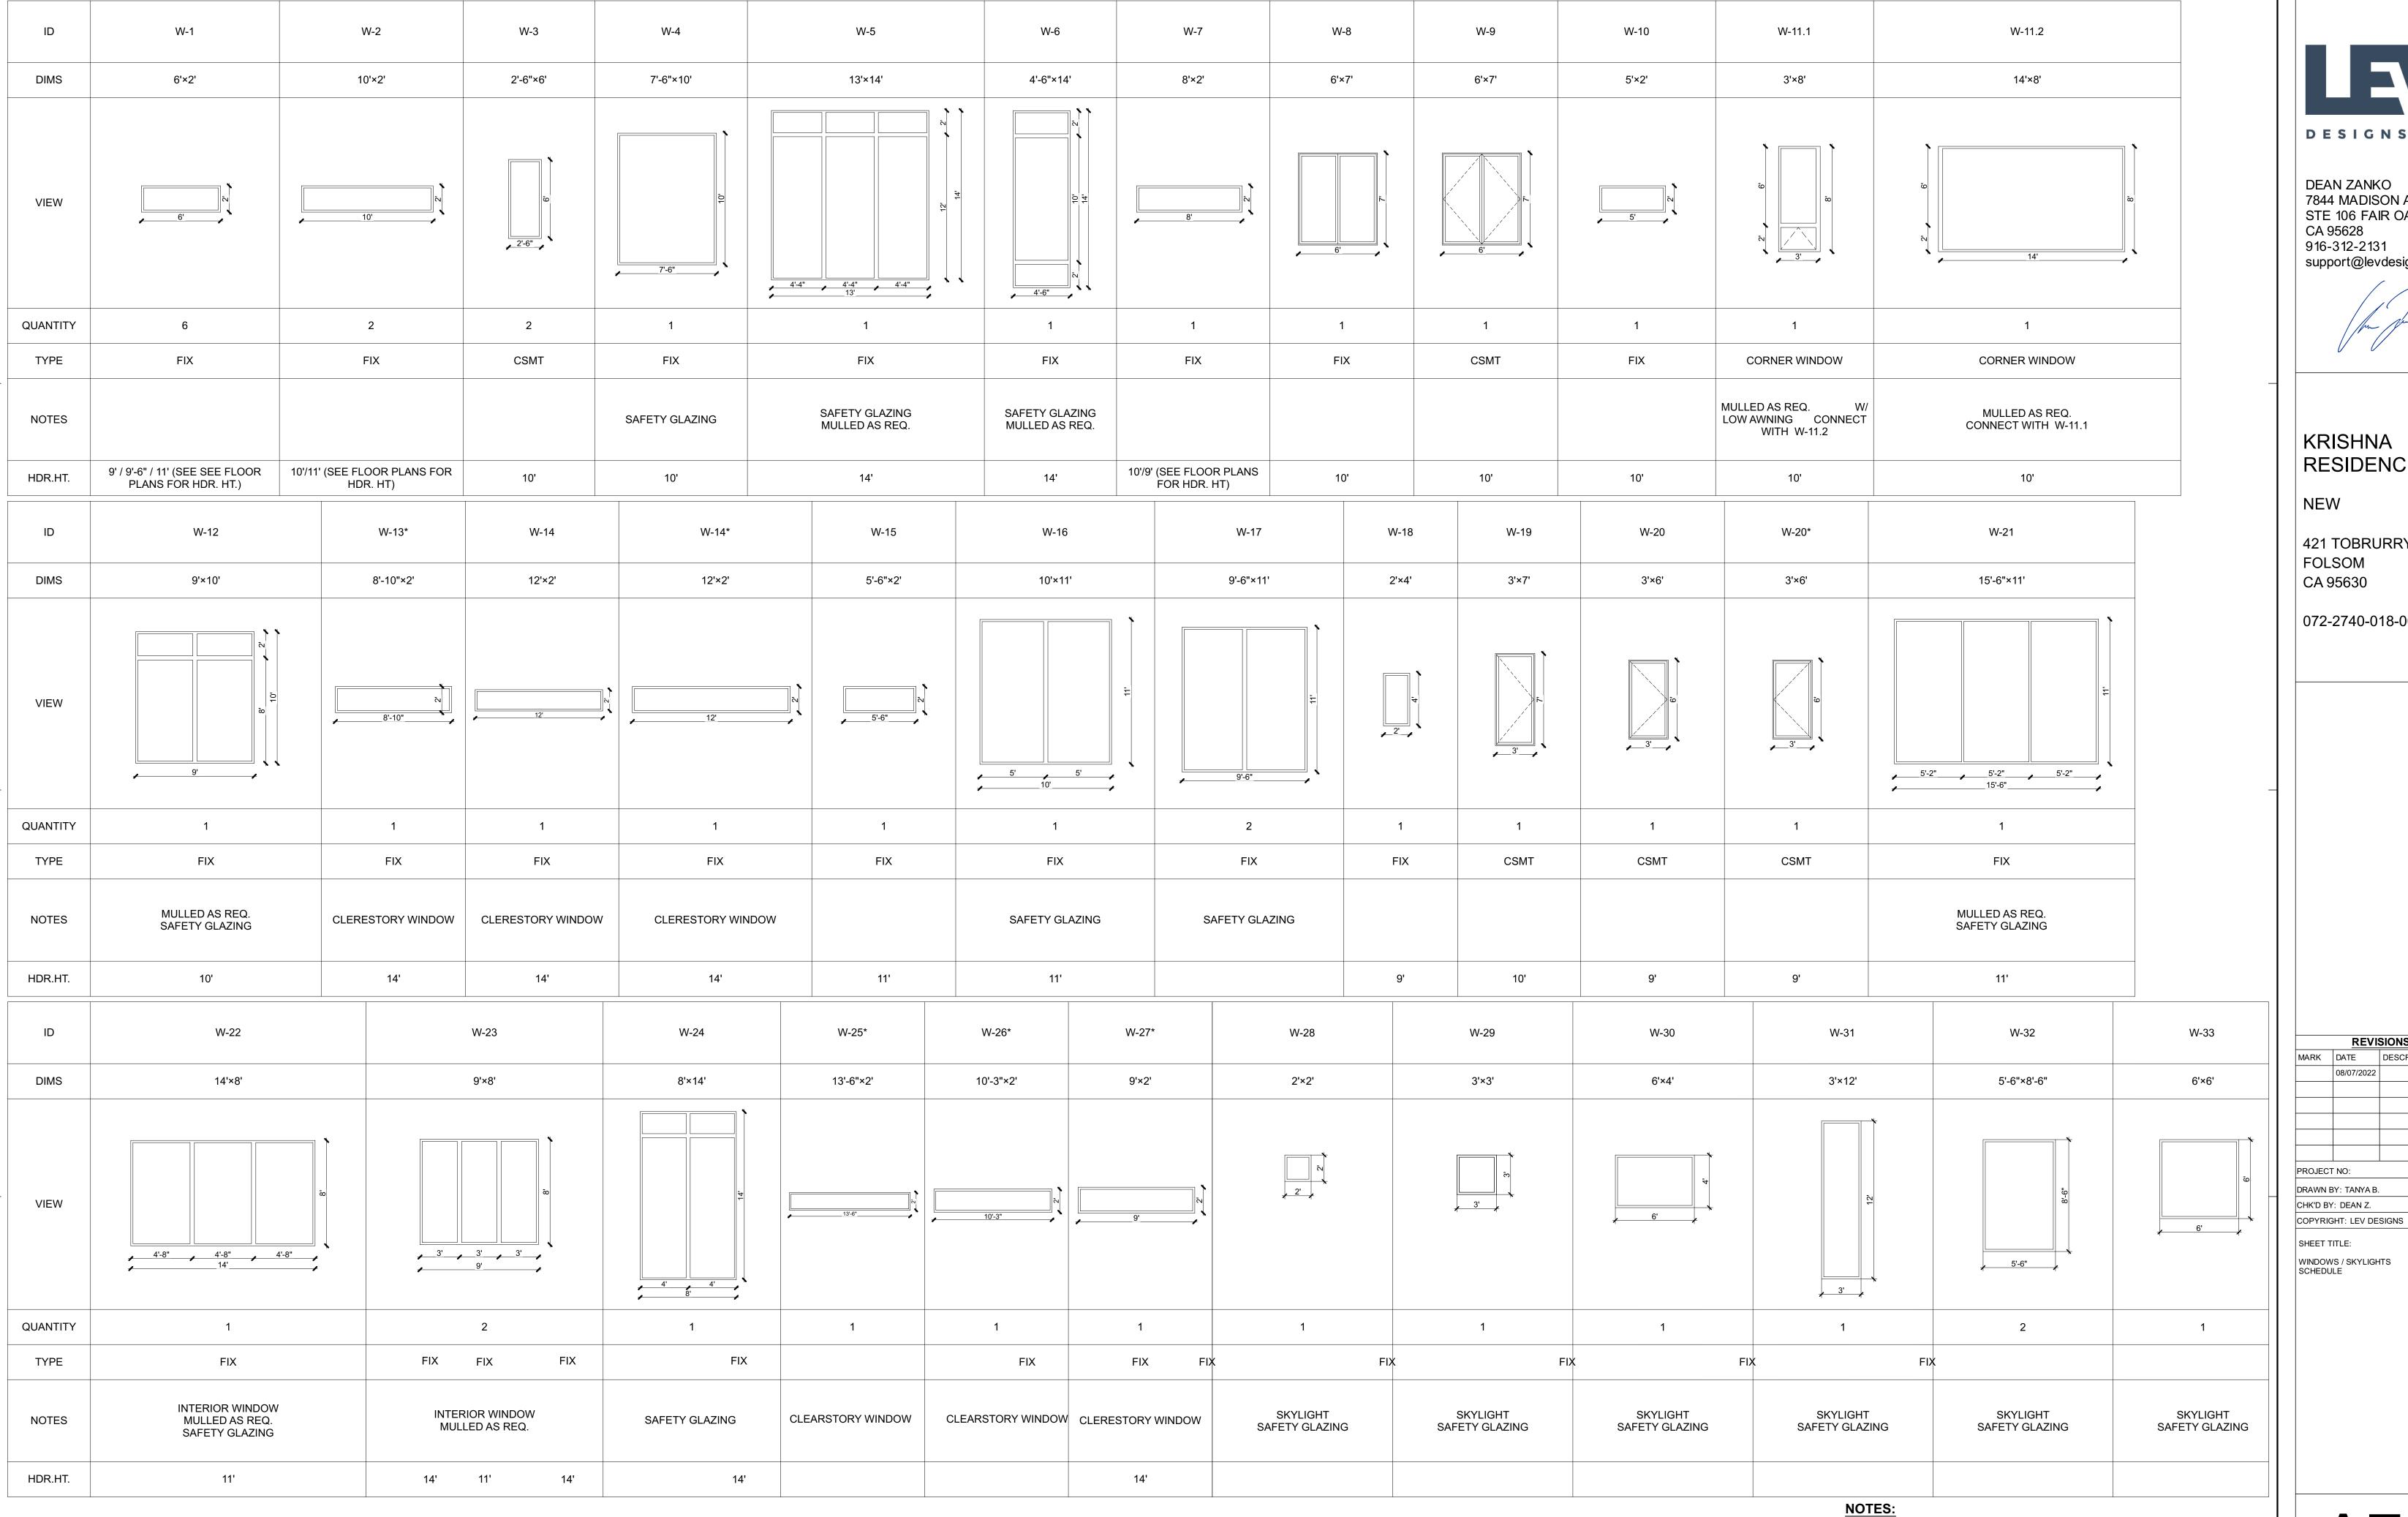
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SHEET TITLE: SECTION 2

<u>1/4" = 1'-0"</u>

A6.1



ALL DIMENSIONS EXCEPT THE OVERALL DIMENSIONS ARE SHOWN TO THE CENTERS IF THE WINDOW/DOORS/SPACERS/MULLIONS. MANUFACTURER TO INCLUDE THE DIMENSIONS OF SPACERS/MULLIONS WHEN DEVELOPING SHOP DRAWINGS AND DURING PRODUCTION.



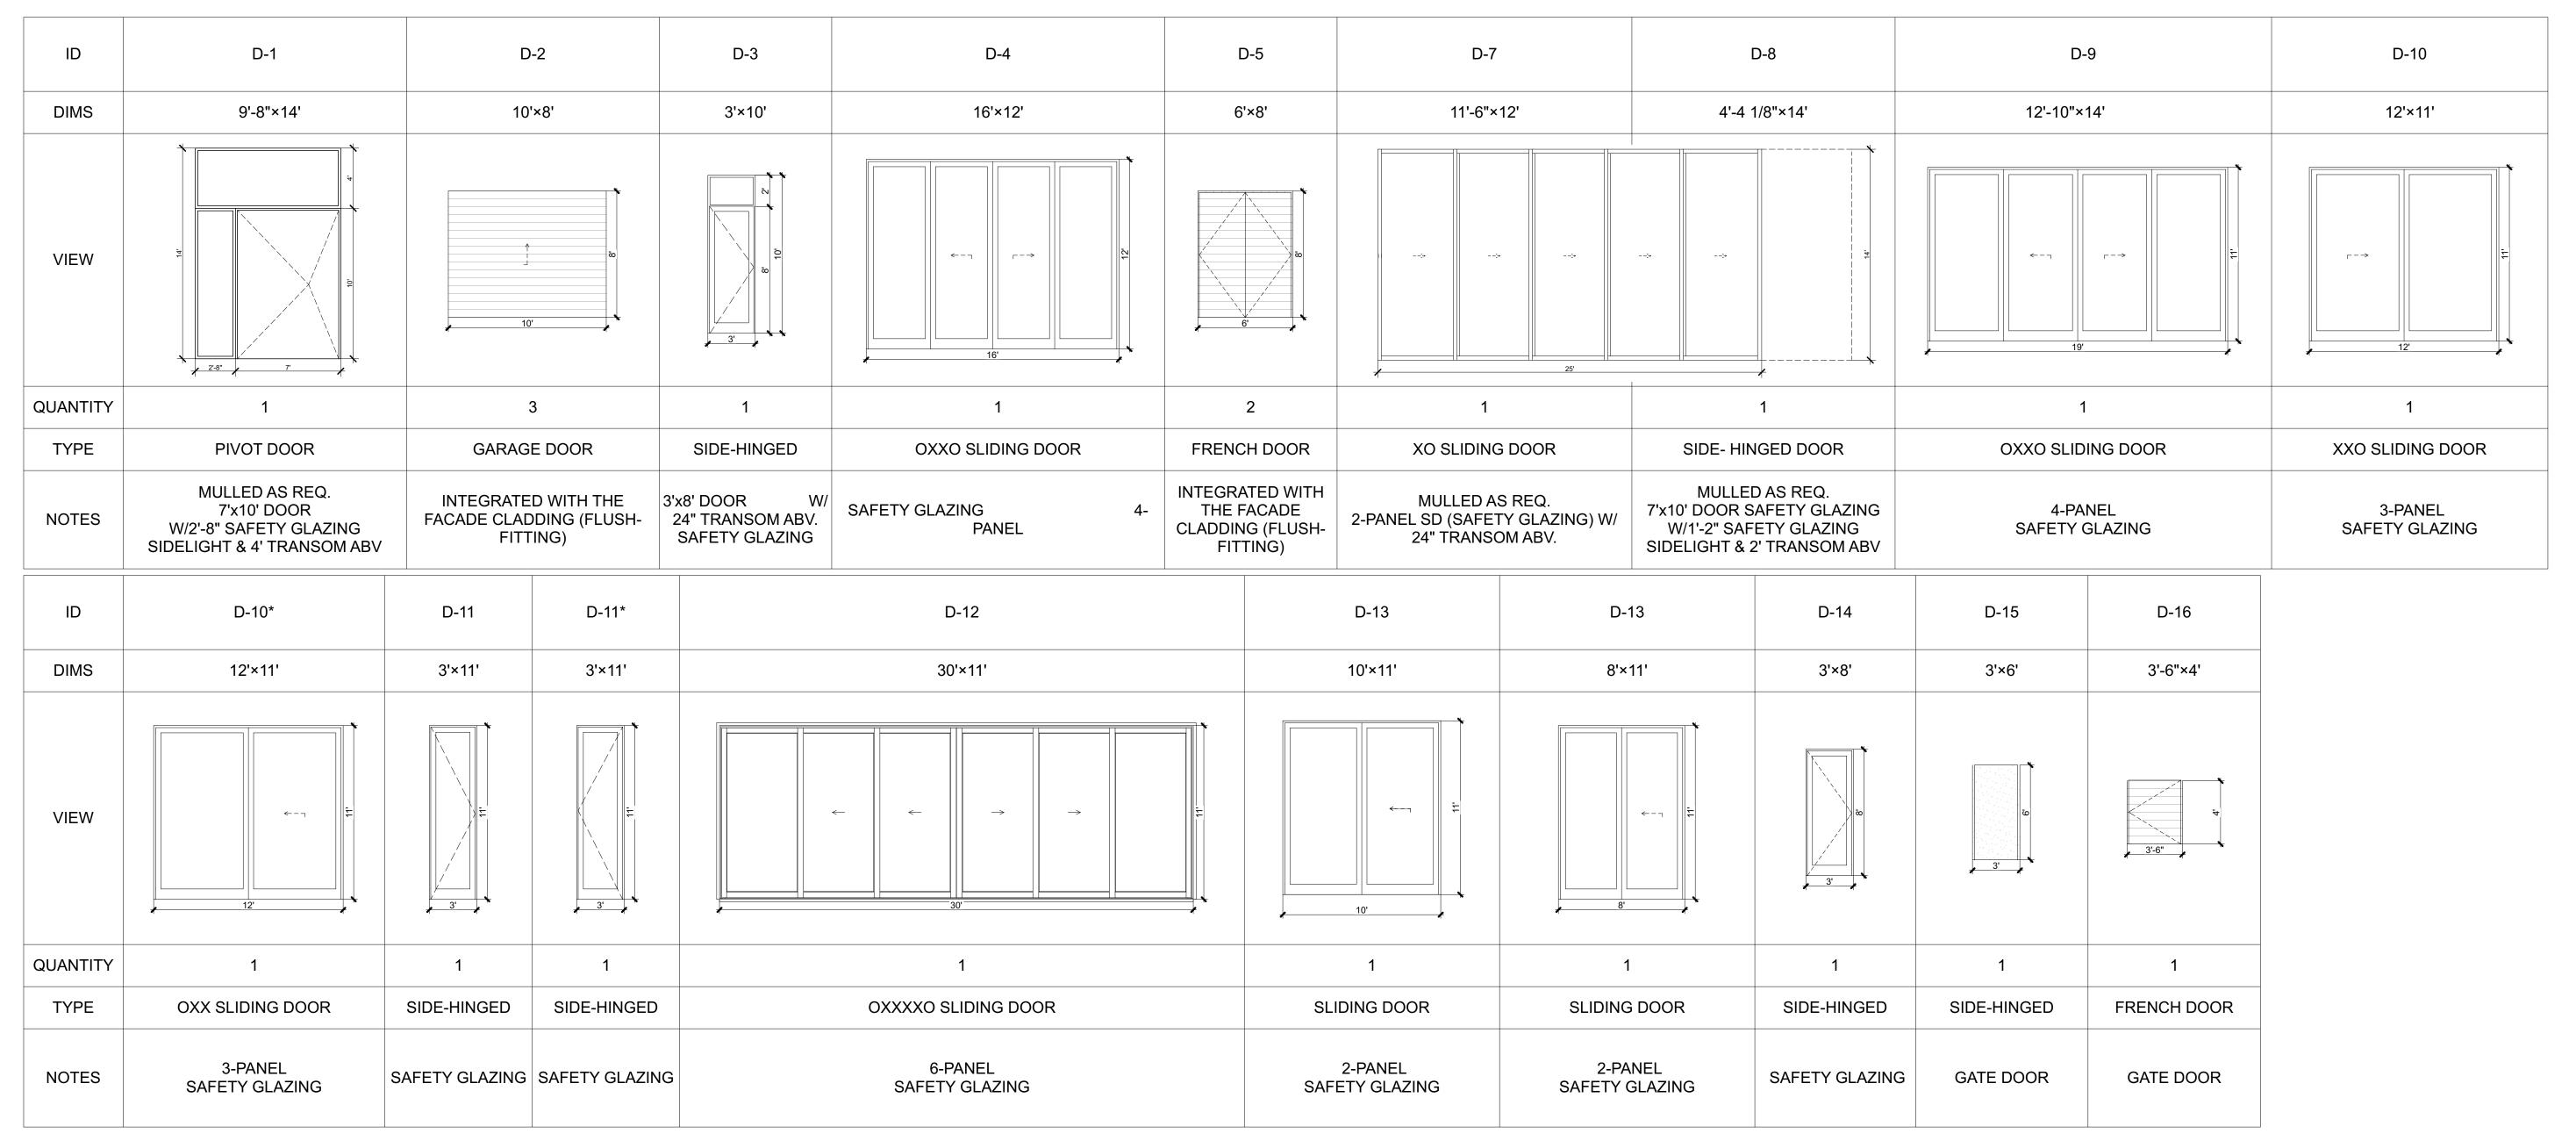
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SPECIFICATIONS DON'T INCLUDE INTERIORS DOORS.



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SHEET TITLE:
DOOR SCHEDULE



PHOTO #1



PHOTO #3



PHOTO #2

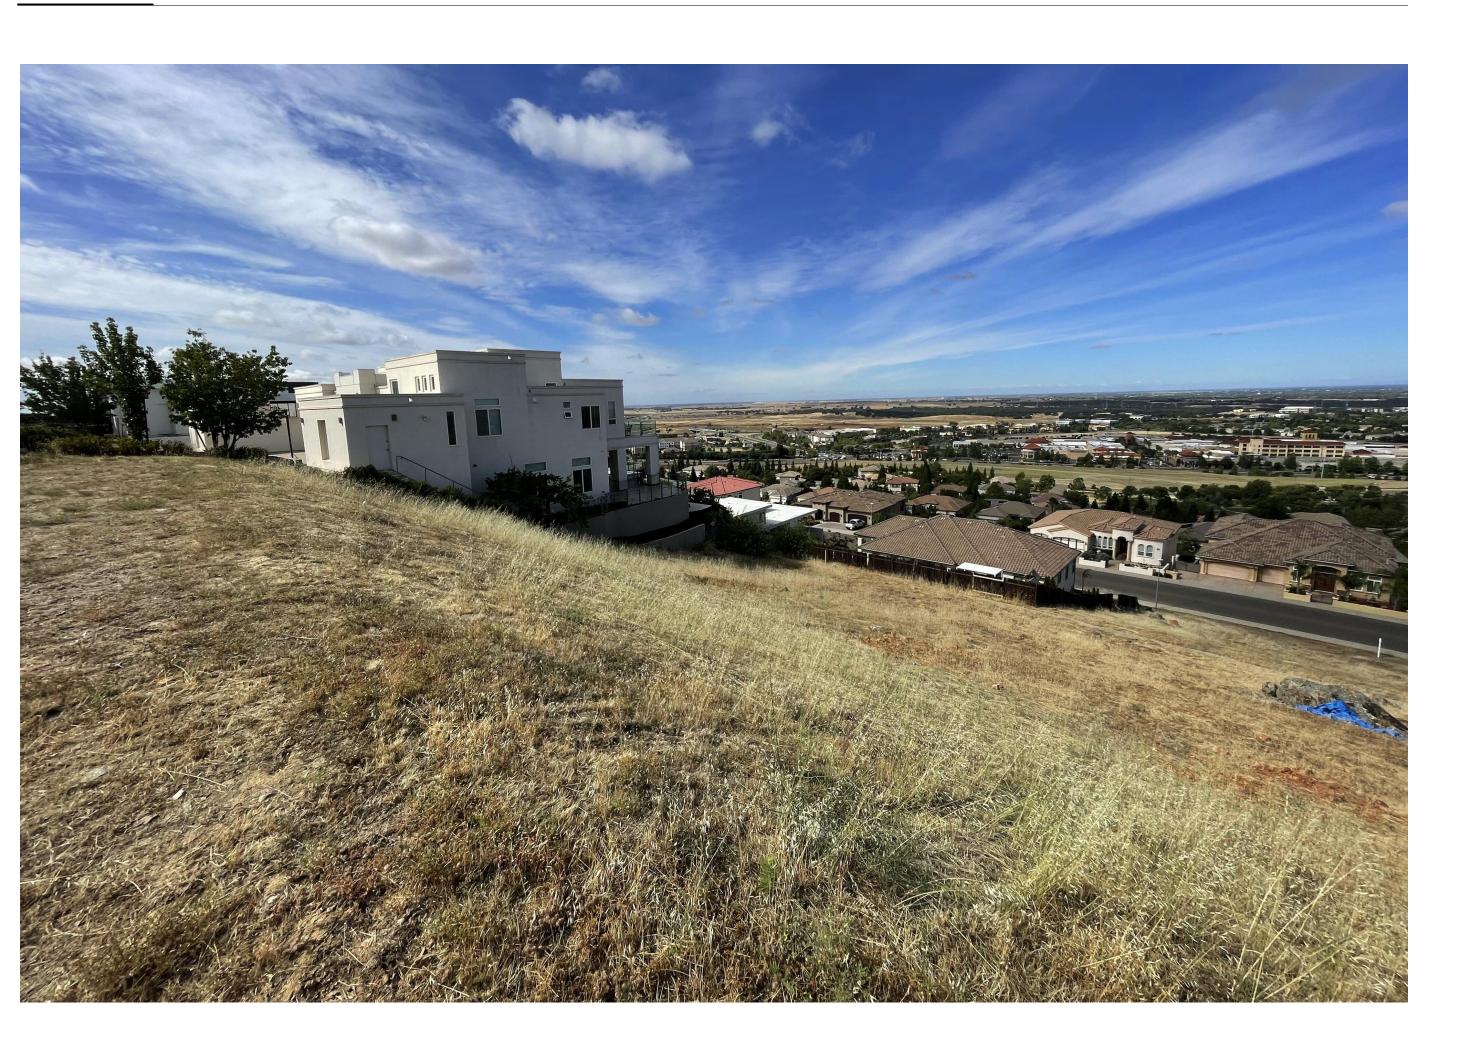


PHOTO #4



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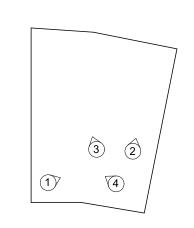
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SHEET TITLE:
PROJECT SITE PHOTOS

A8.0